

THE CORPORATION OF THE TOWNSHIP OF MUSKOKA LAKES

COMMITTEE OF ADJUSTMENT

NOTICE OF PUBLIC HEARING OF APPLICATION FOR MINOR VARIANCE

This notice has been sent to you for your information and does not require any response unless you wish to make one.

TAKE NOTICE THAT the Committee of Adjustment for The Corporation of the Township of Muskoka Lakes will be considering the following proposed minor variance to Zoning By-Law 2014-14 pursuant to Section 45 of the Planning Act, R.S.O. 1990, c. P.13.

Hearing Date: Monday, April 8, 2024 at 9:00 a.m.

File #.: A-21/24 Roll #: 6-1-066

Civic Address: 1182 Ashforth Drive

Owner: Franco Doracin, 785 Canyon Street, Mississauga, ON, L5H 4M3 **Legal Description:** Lot 26, Concession 3, Lot 21, Plan M-477, (Wood)

Lake/River: Lake Muskoka (Category 1 Lake)

Zoning: Waterfront Residential (WR6-7 and WR6-7R)

Zoning Schedule: 42

EXPLANATION OF THE PURPOSE AND EFFECT: The applicant proposes to construct a one storey dwelling addition with a walkout basement, a one storey garage with a walkout basement, and a one storey boathouse.

Variance	ZBL 2014-14 Section(s)	Description	Permitted	Proposed	Variance
А	4.1.3 and	Maximum Lot Coverage	2,627 sq. ft.	2,845 sq. ft.	218 sq. ft.
	4.1.3.6	(Entire Lot)	(10%)	(10.8%)	(0.8%)

A key map of the subject property and the applicants' site plan and any drawings are included in this notice.

TAKE FURTHER NOTICE that this public hearing will be held in a hybrid forum with electronic ZOOM participation, and in-person format for those wishing to attend in person. The meeting will be held in the Council Chambers, Municipal Office, 1 Bailey Street, Port Carling, Ontario, and will commence at 9:00 a.m.

ZOOM Guide

More information about viewing and/or participating in the zoom hearing can be found on our website: https://www.muskokalakes.ca/zoom/

Electronic Version of Notice of Hearing

Should you wish to view an electronic copy of the Notice of Hearing for the above-noted application, please visit

https://www.muskokalakes.ca/planning-notices/ or scan the QR code:





Submit Comments in Writing

Submit comments to planning@muskokalakes.ca, deliver in-person, or mail to P.O. Box 129, 1 Bailey Street, Port Carling, ON, P0B 1J0

Personal information collected in response to this Notice of Hearing will be used to assist staff and Council to process this application and will be made public.



Active Verbal Participation in Person or on Zoom

Hybrid hearings are held at 9:00 a.m. on the above-noted hearing date in Council Chambers at the Municipal Office. For more information about participating via Zoom, visit:

www.muskokalakes.ca/zoom

If you wish to speak to the Committee of Adjustment at the hearing by electronic participation, please contact planning@muskokalakes.ca by 9:00 a.m. on the regular business day preceding the scheduled hearing.



Watch the Meeting Online

You can access the hearing from YouTube on the Township of Muskoka Lakes YouTube Channel. If the live webcast fails, the hearing recording will be posted under the Government Portal on www.muskokalakes.ca

For more information, please contact the Planning Department weekdays between 8:15 a.m. and 4 p.m. at the Municipal Office, or at planning@muskokalakes.ca or by phone at (705) 765-3156. **Please quote the file number noted above.**

FAILURE TO PARTICIPATE: If you do not participate in the hearing it may proceed in your absence and, except as otherwise provided in the Planning Act, you will not be entitled to any further notice in the proceedings.


DECISION & APPEALS: If you wish to be notified of the decision of the Committee of Adjustment in respect to this application, you must make a written request to planning@muskokalakes.ca. Furthermore, no one other than the applicant, the municipality, certain public bodies and the minister may file an appeal of the decision of the Committee of Adjustment in respect of the proposed variance. If they do not make written submission to the Secretary Treasurer before the variance is approved or refused, then the Ontario Land Tribunal may dismiss the appeal.


PLEASE NOTE: THE COMMITTEE OF ADJUSTMENT IS A JUDICIAL BODY WHICH MAKES DECISIONS SOLELY ON INFORMATION GATHERED AS A COMMITTEE. COMMITTEE MEMBERS ARE NOT TO BE CONTACTED PRIOR TO THE HEARING DATE TO AVOID A CONFLICT OF INTEREST.

Dated this 27th day of March, 2024.


"Original Signed by C. Ward"
Chelsea Ward,
Secretary-Treasurer
Committee of Adjustment

KEY MAP

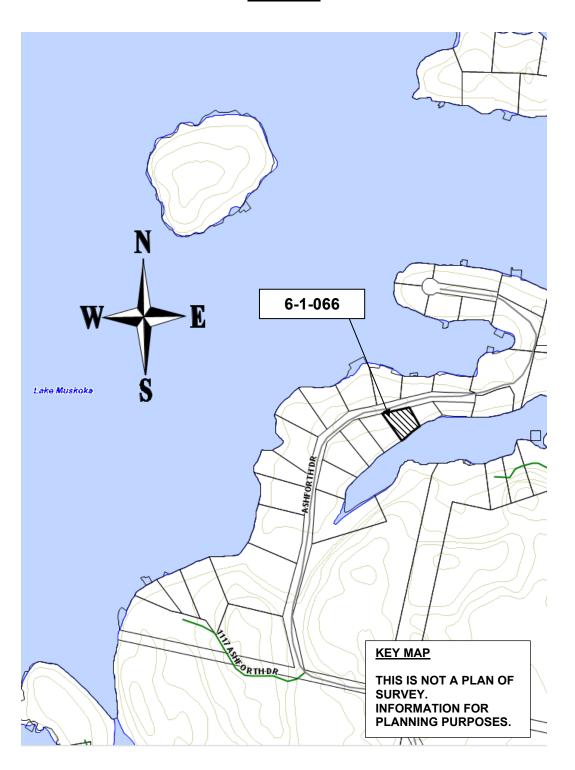

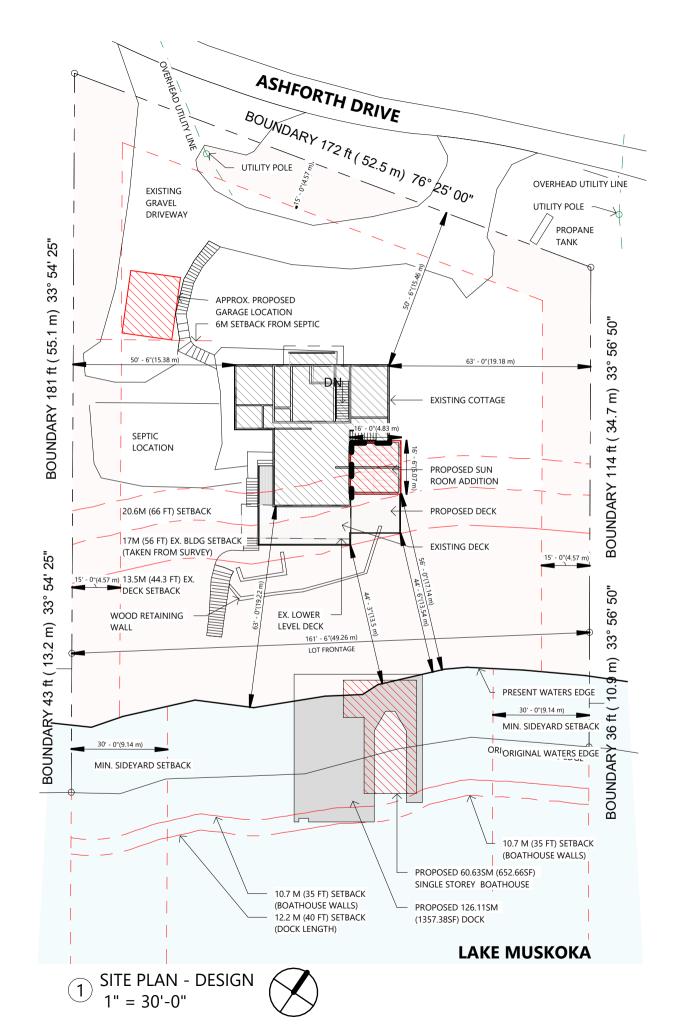

SITE PLAN LEGEND

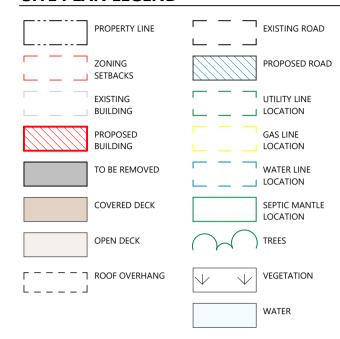

AREA STATISTICS

AREA - SITE

Name Area (SM) Perimeter

SITE AREA (OVERALL & FIRST 61M) 26270 SE 2440.54 m² 667' - 61/8"

AREA - EXISTING LOT COVERAGE

 Name
 Area
 Area (SM)
 Coverage %

 EXISTING COTTAGE
 1645 SF
 152.80 m²
 6.26%

 Grand total: 1
 1645 SF
 152.80 m²
 6.26%

AREA - PROPOSED LOT COVERAGE

Name	Area	Area (SM)	Coverage
EXISTING COTTAGE	1645 SF	152.80 m ²	6.26%
COTTAGE ADDITION PROPOSED	262 SF	24.38 m ²	1.00%
PROPOSED GARAGE	285 SF	26.48 m ²	1.08%
PROPOSED BOATHOUSE	653 SF	60.63 m ²	2.48%
Grand total: 4	2845 SF	264.29 m ²	10.83%

ZONING REQUIREMENTS

PER TBL 4.1.3 & TBL 4.1.7 OF TOWNSHIP OF MUSKOKA LAKES ZONING BY-LAWS (LAKE MUSKOKA) SITE ADDRESS: 1182 ASHFORTH DR. MUSKOKA LAKES, ON POC 1M0 ZONING TYPE = WR6-7 & WR6-7R (-7 IS SUBJECT TO SITE PLAN CONTROL) ROLL NUMBER = 445306000106600

LEGAL DESCRIPTION = CON 3 LOT 26 PLAN M477 LOT 21 (PCL 25144)

	REQUIRED		<u>PROPOSED</u>	<u>)</u>
LOT AREA (MIN)	= 0.8 HA		= 0.244054	HA
LOT FRONTAGE (MIN)	= 122 M	(400 FT)	= 49.26 M	(161.61 FT)
LOT COVERAGE (MAX) (FIRST 61M)	= 11%		= 10.83%	
REQUIRED YARDS				
FRONT YARD (MIN)	= 20.1 M	(66 FT)	= 17 M	(56 FT)
EXTERIOR SIDE YARD (MIN)	= 9.1 M	(30 FT)	= N/A	
REAR YARD (MIN)	= 4.6 M	(15 FT)	= 15.5 M	(51 FT)
INTERIOR SIDE YARD (MIN)	= 4.6 M	(15 FT)	= 15.5 M	(51 FT)
BUILDING HEIGHT (MAX)(highest point of roof)	= 10.7 M	(35 FT)	= 8.23 M	(27 FT)
ACCESSORY STRUCTURES AND BUILDINGS				
BUILDING HEIGHT (MAX)(highest point of roof) FRONT YARD SETBACK EXCEMPTIONS	= 6.1 M	(20 FT)	= 3.31 M	(11.5 FT)
PUMPHOUSE GFA (MAX)	= 4.6 SM	(50 SF)	= # M	(# FT)
SAUNA GFA (MAX)	= 9.3 SM	(100 SF)	= # M	(# FT)
GAZEBO GFA (MAX)	= 18.6 SM	(200 SF)	= # M	(# FT)
(PH, S, G.) BLDG HGHT(MAX)(highest pt of roof)	= 4.6 M	(15 FT)	= # M	(# FT)
(PH, SAUNA, GAZ.) SEPARATION FROM BLDGS	= 4.6 M	(15 FT)	= # M	(# FT)
SUNDECK SETBACK FROM HWM (MIN)	= 15.2 M	(49.87 FT)	= # M	(# FT)
PH & SAUNA SETBACK FROM HWM (MIN)	= 4.6 M	(15 FT)	= # M	(# FT)
GAZEBO SETBACK FROM HWM (MIN)	= 1.0 M	(3 FT)	= # M	(# FT)

4.1.6.v. A gazebo exceeding 18.6m2 (200ft2) in floor area, which is screened or glassed, shall be considered to be a sleeping cabin.

4.1.6.vi. where a habitable room is located in an attached garage which is attached by means of a walkway, breezeway or other such passage, the max. height shall be 10.7m (35ft) and the max. floor area of all such habitable rooms shall be 60.4m2 (650ft2)

SHORELINES STRUCTURES AND FACILITIES

DOCKS				
DOCK LENGTH (25% or 12.2)	= 12.20 M	(40 FT)	= 12.2 M	(40 FT)
DOCK WIDTH (CUMULATIVE MAX) (25% or 22.9)	= 12.32 M	(40.40 FT)	= 12.19 M	(40 FT)
DOCK SETBACK (MIN)	= 9.10 M	(30 FT)	= 15.83 M	(52 FT)
BOATHOUSES				
# OF BUILDING STOREYS PERMITTED	= 1		= 1	
BOATHOUSE LENGTH (MAX) (25% or 10.7)	= 10.70 M	(35 FT)	= 10.7 M	(35 FT)
1ST STOREY WIDTH (MAX) (16% or 22.9)	= 7.88 M	(25.85 FT)	= 6.96 M	(23 FT)
BOATHOUSE SETBACK (1 STOREY)	= 9.1 M	(30 FT)	= 16.44 M	(54 FT)
HABITABLE FLOOR AREA	= NO			
BLDG HEIGHT (MAX)(highest point of roof)	= 4.9 M	(16 FT)	= 4.83 M	(15.83 F
<u>4.1.7.19 -</u>				

For those portions of land fronting onto a restricted waterbody and zoned with a "-R" suffix to the zone symbol, a dock, boathouse, boatport, or sun shelter may be located in the abutting Waterbody Open Space (WOS) zone and subject to the following additional provisions:

a. The maximum length of a dock, measured from the high water mark, is the lesser of 12.2 m (40 ft.) or 25% of the distance from shoreline to opposite shoreline as established by the Schedules to By-law 2014-14, measured from the subject dock to the closest shoreline of another lot opposite the subject dock;

b. The maximum length of a boathouse, boatport or sun shelter, measured from the high water mark, is the lesser of 10.7 m (35 ft.) or 25% of the distance from shoreline to opposite shoreline as established by the Schedules to By-law 2014-14, measured from the subject boathouse to the closest shoreline of another lot opposite the subject boathouse;


c. A two storey boathouse is not permitted; and

d. A single storey boathouse, boatport or sun shelter where the roof is capable of being used as a sundeck shall not be permitted.



COTTAGE ADDITION

LOCATION MAP

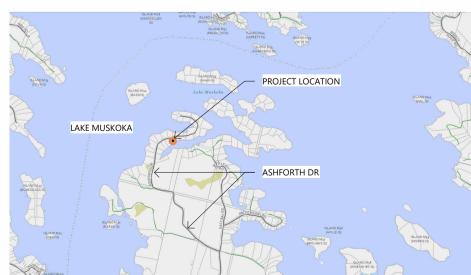

FOR INFORMATIONAL PURPOSES ONLY

Level Area Area (SM) SITE AREA (OVERALL & FIRST 1ST FL. 26270 SF 2440.54 m² COTTAGE ADDITION PROPOSED 1ST FL. 262 SF 24.38 m² 1ST FL. 285 SF 26.48 m² 1ST FL. 653 SF 60.63 m² PROPOSED BOATHOUSE

PROJECT INFORMATION INSULATION REQUIREMENTS SB-12 - 3.1.1.2.A - A2 CEILING WITH ATTIC CEILING W/O ATTIC EXPOSDE FLOOR WALL ABOVE GRADE BASEMENT WALLS BELOW GRADE SLAB HEATED SLAB EDGE OF BELOW GRADE SLAB

WINDOWS / GLASS DOORS

SPACE HEATING EQUIPMENT

DOMESTIC WATER HEATER

CI = CONTINUOUS INSULATION

REVISION SCHEDULE # DATE DESCRIPTION 1 2022_0105 DESIGN APPROVAL 2 2023_1215 ISSUED FOR PERMIT

PROJECT CONTACTS

1182 ASHFORTH DRIVE, MUSKOKA LAKES ON, P0C 1M0

CONTACT: FRANK DORACIN PHONE NUMBER FRANK@DORACINTSL.COM

CONTACT: PERSON NAME PHONE NUMBER COMPANY EMAIL

S101 1ST FL. FRAMING PLAN A001 NOTES AND LEGENDS S102 ROOF FRAMING PLAN S105 ROOF TRUSS PROFILES 1 S200 N/S FRAMING ELEVATION

S201 E/W FRAMING ELEVATION

A200 BASEMENT PLAN / DEMO A201 1ST FL. PLAN / DEMO A202 ROOF PLAN / DEMO A300 EXISTING ELEVATIONS A301 ELEVATIONS A400 SECTIONS

SHEET LIST

A000 COVER SHEET

A401 DETAILS E100 BSMT. & 1ST POWER & DATA E101 2ND POWER & DATA E200 BSMT. AND 1ST. SWITCHING E201 2ND FL. SWITCHING

S100 STRUCTURAL PLANS

1182 ASHFORTH DR, MUSKOKA LAKES, ON

DESIGNER

887.562.1959

CONTACTS

CORBIN PATTEN

887.562.1959 EXT. 1

PRINCIPAL

CORBIN PATTEN DESIGNS

1150 HWY. 141, ROSSEAU, ON

DESIGN@CORBINPATTEN.COM


CORBIN@CORBINPATTEN.COM

CONTRACTOR TBD

FRANK DORACIN AND ELIZABETH HARDING

NOT TO SCALE

2 1ST FL. - EXISTING / DEMO 1/8" = 1'-0" 0'

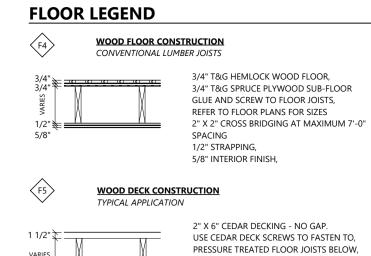

USE CEDAR DECK SCREWS TO FASTEN TO. PRESSURE TREATED FLOOR JOISTS BELOW. REFER TO FLOOR PLANS FOR SIZES 2" X 2" CROSS BRIDGING AT MAXIMUM 7'-0"

SPACING

2X6 WOOD CONSTRUCTION EXTERIOR WALL W/ RIGID INSULATION 3/4" WOOD SIDING 1" RIGID FOAM 2X6 WOOD CONSTRUCTION INTERIOR WALL

5/8" INTERIOR FINISH

WALL LEGEND

1/2 x 2" WOOD STRAPPING 5 1/2" STUD WITH BLOW IN BATT INSULATION



2X4 WOOD CONSTRUCTION 5/8" INTERIOR FINISH 3 1/2" STUD WITH ROXUL INSULATION FOR SOUND 5/8" INTERIOR FINISH

INSULATED CONCRETE MASONRY UNIT

DRAINAGE BOARD (BELOW GRADE) OR SIDING (A.F.G.) 8" CONCRETE BLOCK WALL 3 1/2" STUD WITH BLOWN-IN BATT INSULATION

STANDARDS SHOULD BE REPAIRED AND BROUGHT IN COMPLIANCE. ALL STRUCTURAL ISSUES TO BE BROUGHT TO THE ATTENTION BUILDING DESIGN AND ENGINEER. WALLS TO BE REMOVED AND DEMOLISHED UNLESS _ _ _ _ NOTED OTHERWISE

(61) DEMOLISH WALL

(62) DEMOLISH FLOOR (63) DEMOLISH ROOF

DEMOLISH BEAM, JOIST, COLUMN, FOUNDATION

DISCONNECT ELECTRICAL AND RELOCATE ELECTRICAL AND / OR ELECTRICAL PANEL


69 SHORE STRUCTURE LOAD BEARING WALLS, FLOORS, AND ROOF TO BE SHORED WHERE APPLICABLE


70 DEMOLISH STAIRS STAIRS TO BE REMOVED AND CONTRACTOR TO PROVIDE TEMPORARY RAILING

 $\langle 71 \rangle$ SAFETY RAILING CONTRACTOR TO BUILD SAFTEY RAILINGS IN OPENINGS WHERE APPLICABLE UNTIL AREA IS MADE CODE COMPLIANT

73 DEMOLISH FIREPLACE

FOR INFORMATIONAL PURPOSES ONLY

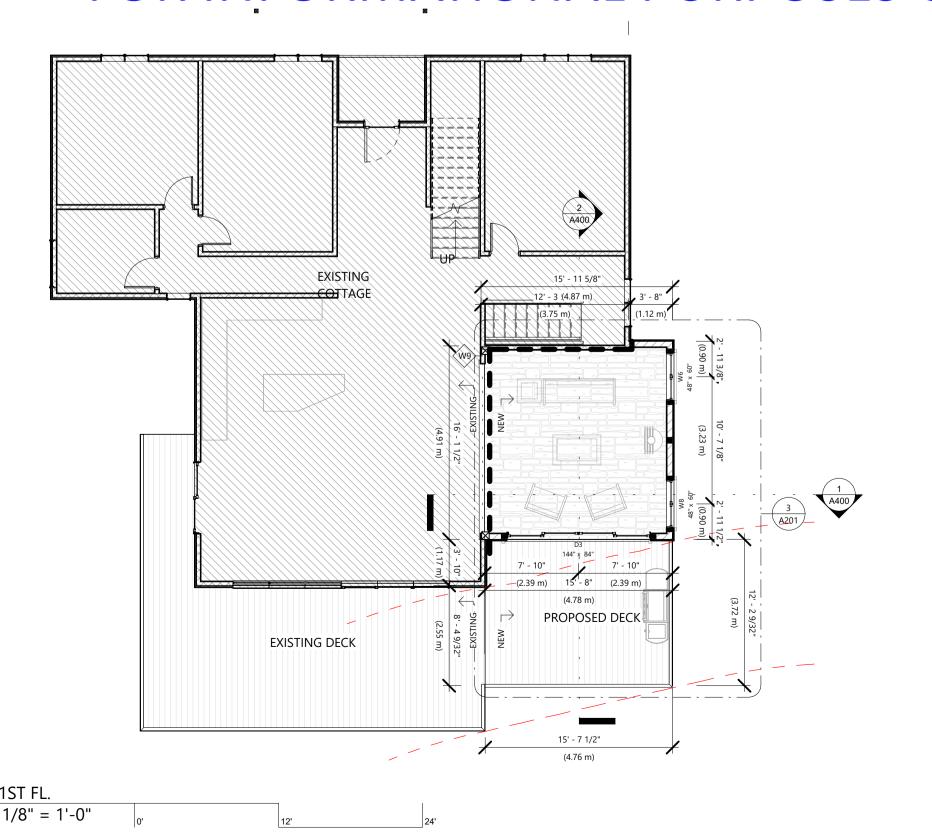

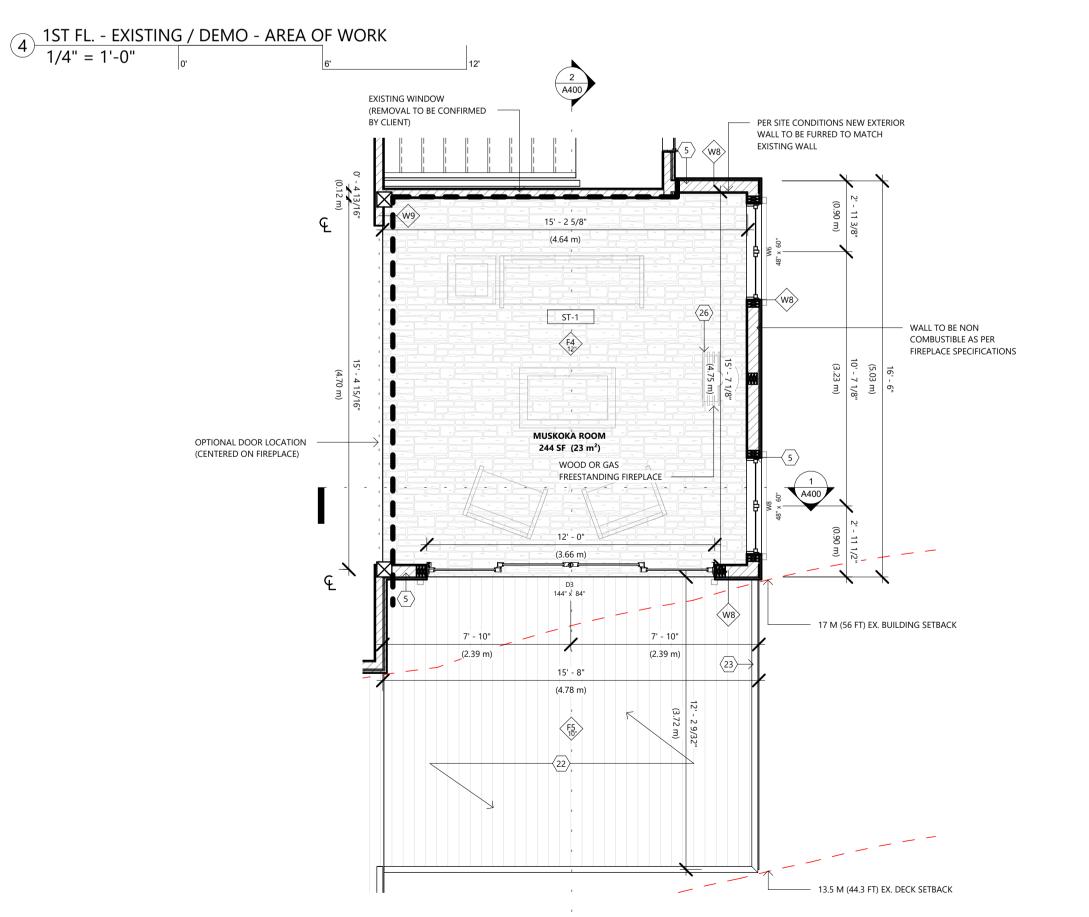

GENERAL NOTES - EXISTING/DEMO PLANS

- PRIOR TO DEMOLISHING ANY EXISTING COMPONENTS, CONTRACTOR TO VERIFY ANY EXISTING MECHANICAL PILIMBING AND FLECTRICAL SERVICES THAT MAY BE WITHIN DEMOLITION SCOPE ARE DISCONNECTED AND DEEMED SAFE TO DEMOLISH - CONTRACTOR TO VERIFY ANY PARTITIONS AND WALLS ARE NOT LOAD BEARING PRIOR TO THE DEMOLITION OF THESE WALLS. IF THEY ARE LOAD BEARING THEN NOTIFY THE BUILDING DESIGNER AND ENGINEER PRIOR TO ANY DEMOLITION WORK. - ALL SURFACES TO BE BROUGHT TO SAFE AND CLEAN CONDITION AFTER DEMOLITION OF ANY PARTITIONS, WALLS, FLOORS AND CEILINGS AND OTHER BUILDING COMPONENT

- ALL EXISTING STRUCTURE INCLUDING LOAD BEARING WALLS, BEAMS, RAFTERS, JOISTS, LINTELS, COLUMNS, FOUNDATIONS, AND FOOTINGS TO BE VERIFIED FOR THEIR STRUCTURAL STABILITY. ALL SHORTCOMINGS INCLUDING SIGNS OF DECAY, WROUGHT, PERMANENT BENDING, AND ANYTHING ELSE DEEMED TO NOT MEET CURRENT BUILDING CODE

DOORS TO BE REMOVED AND DEMOLISHED UNLESS WINDOWS TO BE REMOVED AND DEMOLISHED

64 DEMOLISH STRUCTURE

(65) DEMOLISH WINDOW / OPENING

(66) FILL IN WALL / OPENING (67) DEMOLISH ELECTRICAL

(68) SAW CUT FLOOR FOR NEW PLUMBING / ELECTRICAL

PRIOR TO DEMOLISHING

(72) WALL TO BE ALTERED WALL TO BE ALTERED, EXTERIOR MATERIAL TO BE REMOVED, NEW OPENINGS TO BE PROVIDED.

REMOVE FIREPLACE IN ITS ENTIRETY, PATCH ROOF AS REQUIRED

GENERAL NOTES - PLANS

- ALL DIMENSIONS ARE TO THE EDGE OF THE STUD AND DO NOT INCLUDE FINISH MATERIALS. - ALL CONCRETE TO BE 24 MPa UNLESS SPECIFIED ON DRAWINGS. - ST-1 FLAGSTONE FLOORING TO BE DETERMINED BY CLIENT

(3) STUD ON FOUNDATION WALL INTERIOR FOUNDATION WALL AS PER NOTE. 1/2" SPACE BETWEEN STUD AND CONCRETE WALL 3 1/2" STUD WITH SPRAY FOAM INSULATION INTERIOR FINISH AS PER DRAWINGS OR AS SPECIFIED BY BUILDING DESIGNER

AND OWNER. 5 EXTERIOR WALL EXTERIOR FINISH AS SPECIFIED.

1/2" STRAPPING TO BE FASTENED AND ALIGNED WITH STUDS SPACED AT 16" AIR BARRIER 1/2" PLYWOOD SHEATHING WALL STUDS TO BE SPACED AT 16" O/C OR AS OTHERWISE SPECIFIED. INSULATION REQUIRED AS PER WALL TYPE. BATT OR SPRAY FOAM INSULATION TO MEET DESIGN CRITERIA OR APPLICABLE CODES.

INTERIOR FINISH DOUBLE PLATE @ TOP AND SINGLE PLATE @ BOTTOM. WALLS TO BE BLOCKED HORIZONTALLY A MID POINT 6 INTERIOR WALL

1" AMVIC SILVERBOARD RIGID INSULATION OR 1.5" ZIP R SHEATHING (1/2" OSB

STUD TO BE FILLED WITH ROXUL INSULATION FOR SOUND PROOFING WALLS TO BE BLOCKED HORIZONTALLY A MID POINT $\langle 7 \rangle$ EXTERIOR RIGID INSULATION

CONTINUOUS RIGID FOAM INSULATION

SEE SCHEDULE.

WITH 1" RIGID FOAM) TO BE DEFAULT EXTERIOR INSULATION OR AS SPECIFIED BY DRAWINGS. DOORS TO HAVE A BLACK EXTERIOR FINISH OR AS SPECIFIED BY DRAWINGS SPECIFICATION TO BE APPROVED BY BUILDING DESIGNER AND OWNER. ALL WINDOWS AND DOORS TO BE ALIGNED WITH THE TOPS AT THE SAME SEE SCHEDULE

21 WINDOWS WINDOWS TO HAVE A BLACK EXTERIOR AND BLACK INTERIOR FINISH OR AS SPECIFIED BY DRAWINGS DOUBLE PANEL, LOW-E, AND GAS FILLED. SPECIFICATION TO BE APPROVED BY BUILDING DESIGNER AND OWNER. ALL WINDOWS AND DOORS TO BE ALIGNED WITH THE TOPS AT THE SAME

22 EXTERIOR DECKS EXTERIOR DECKS TO BE 2 X 6 " BROWN PRESSURE TREATED DECKING.

RAILING TO BE 42" (1.07M) IN HEIGHT WITH DISTANCE ABOVE GRADE MORE THAN 71" (1.8M) OTHERWISE RAILING TO BE 35 1/2" (0.9M) IN HEIGHT. RAILING OPENINGS TO BE NOT MORE THAN 4" (.1M)

STAIR RISE TO BE NOT LESS THAN 5" (0.125M) AND NOT MORE THAN 7 7/8" TREAD DEPTH NOT LESS THAN 9 1/4" (0.235M) AND NOT MORE THAN 13 7/8" STAIR RAILINGS TO BE A MIN. OF 34" (0.865M) AND A MAX. 38" (0.965M) IN HEIGHT

26 FIREPLACE WOOD BURNING OR GAS FIREPLACE INSERT TO BE LOCATED MAIN LEVEL. TOP OF FIREPLACE CHIMNEYS SHALL BE 900mm (2'-11") ABOVE HIGHEST AT WHICH IT COMES IN CONTACT WITH THE ROOF AND 600mm (23 5/8") ABOVE ROOF SURFACE OR STRUCTURE (INCLUDING ADJACENT BUILDINGS) WITHIN A HORIZONTAL DISTANCE OF 3000mm (9'-10") FROM THE CHIMNEY. MAX. UNSUPPORTED CHIMNEY IS 3600 mm (11'-10") ABOVE LAST POINT OF LATERAL COMBUSTION AIR SUPPLY TO FIREPLACE MIN. 100mm (4") DIA. INSULATED NON-COMBUSTIBLE DUCT WITH OPERABLE DAMPER AND INSECT SCREEN 50mm (2") CLEARANCE TO COMBUSTIBLES.

(27) SMOKE ALARM AND CARBON DIOXIDE SMOKE ALARMS AND CARBON DIOXIDE TO BE INSTALLED ON EACH STOREY, INCLUDING BASEMENTS, AND TO BE LOCATED IN EACH SLEEPING ROOM OR A LOCATION BETWEEN THE SLEEPING ROOMS. SMOKE ALARMS SHALL BE WIRED SO THAT THE ACTIVATION OF ONE ALARM WILL CAUSE ALL ALARMS WITHIN THE DWELLING UNIT TO SOUND.

30 STONE OR BRICK VENEER VENEER TO BE INSTALLED WITH MORTAR ON REINFORCEMENT MESH. 1/2" CEDAR BREATHER TO BE USED AS AIR SPACE UNDER REINFORCING MESH. REINFORCEMENT MESH TO BE SCREWED TO CONCRETE BOARD. STONE VENEER TO ATTACH TO CONCRETE BLOCK WALL WITH METAL TIES @ 400mm (16") 0.C. H0RIZ., 600mm (24") 0.C. VERTICAL

(33) HORIZONTAL SIDING 6" BEVEL HORIZONTAL WOOD SIDING, PAINT ALL SIDES

43 CABINETRY CABINETRY AND MILLWORK AS PER DRAWINGS. UPPER CABINETRY LIGHTING TO BE COORDINATED WITH OWNER AND BUILDING DESIGNER. BATHROOM VANITY AND MILLWORK AS PER CABINETRY MANUFACTURER'S LAYOUT, C/W FULL HEIGHT x VANITY WIDTH MIRROR. BATHROOM VANITY TO BE COORDINATED WITH OWNER AND BUILDING MANUFACTURER TO CONFIRM LOCATION OF APPLIANCES WITH OWNER AND

BUILDING DESIGNER. 44 SEPARATION OF GARAGE SEPARATION OF GARAGES SHALL CONFORM TO 9.10.9.16 AN AIR BARRIER SHALL BE INSTALLED BETWEEN THE GARAGE AND THE REMAINDER OF THE BUILDING TO PROVIDE AN EFFECTIVE BARRIER TO GAS AND

46 WOOD FLOORING 3/4" TONGUE AND GROOVE WOOD FLOOR TO BE COORDINATED WITH OWNER

AND BUILDING DESIGNER. 1/2" TILE FLOOR TO BE COORDINATED WITH OWNER AND BUILDING DESIGNER.

CLOSET FINISH, ROD & SHELF, EXCEPT FOR MASTER BEDROOM WALK IN

TILE FLOOR TO BE PLACED ON UNDERLAY. 54 INTERIOR FINISH TRIM TO BE APPROVED BY OWNER AND BUILDING DESIGNER. LINEN CLOSET PROVIDE 5 ADJUSTABLE WOOD SHELVES.

CLOSETS, WILL HAVE CUSTOM BUILT-INS TO LATER DETAIL. 59 MDF WALL CONSTRUCTION 1X8" T&G MDF WALL. WALL TO HAVE SQUARE NICKEL REVEAL. 2 2023_1215 ISSUED FOR PERMIT

CORBIN PATTEN DESIGNS

1150 HWY #141 ROSSEALL ON


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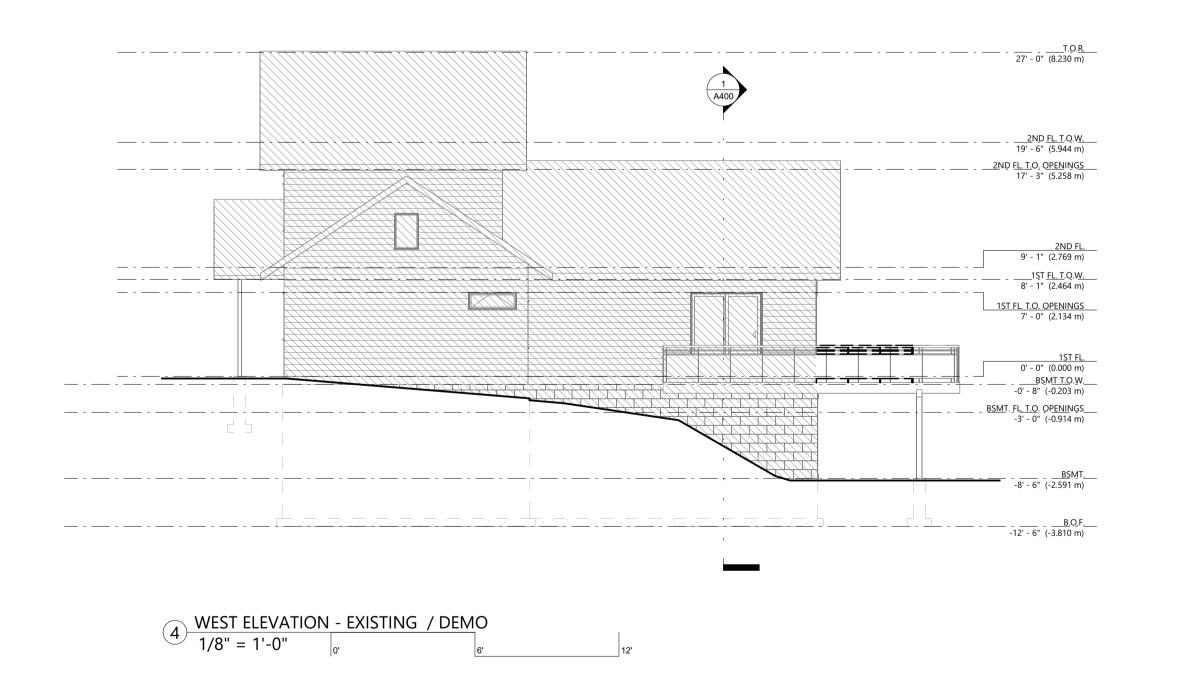
8' - 0" TBD BY CLIENT TBD BY CLIENT TBD BY CLIENT TBD BY CLIENT 0.00 CF 61' - 8 3/4" 244 SF 0.00 CF 61' - 8 3/4"

NOT TO SCALE







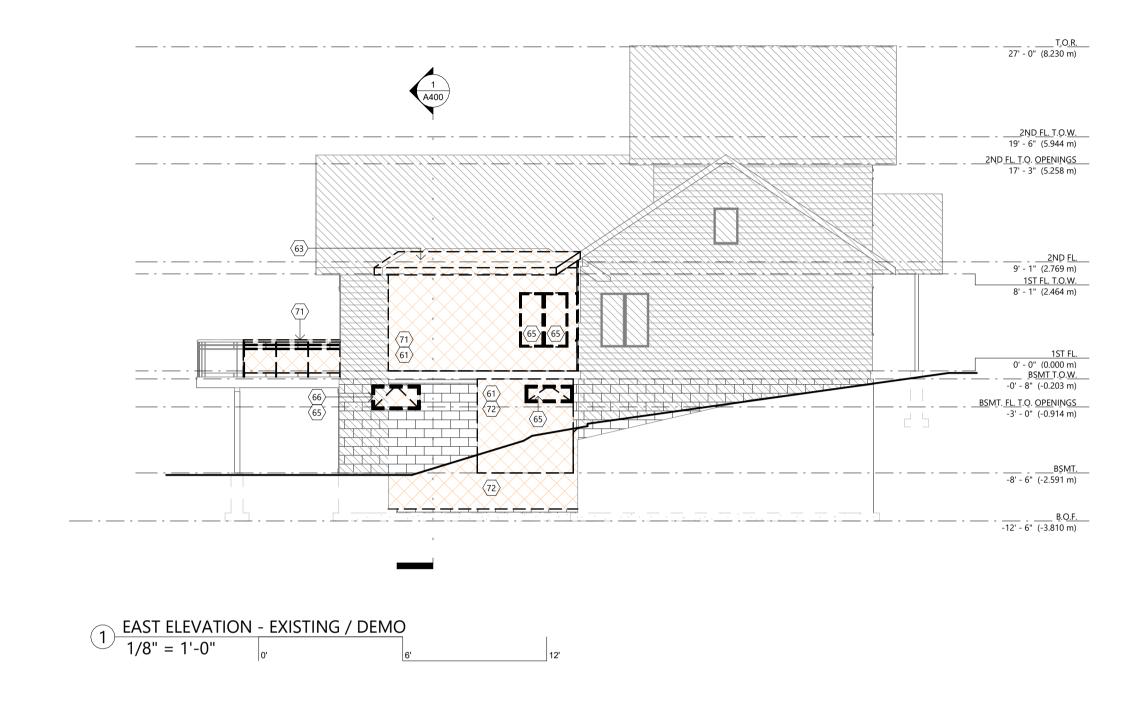


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GENERAL NOTES - EXISTING/DEMO PLANS

- PRIOR TO DEMOLISHING ANY EXISTING COMPONENTS, CONTRACTOR TO VERIEY ANY EXISTING MECHANICAL, PLUMBING, AND ELECTRICAL SERVICES THAT MAY BE WITHIN DEMOLITION SCOPE ARE DISCONNECTED AND DEEMED SAFE TO DEMOLISH - CONTRACTOR TO VERIFY ANY PARTITIONS AND WALLS ARE NOT LOAD BEARING PRIOR TO THE DEMOLITION OF THESE WALLS. IF THEY ARE LOAD BEARING THEN NOTIFY THE BUILDING DESIGNER AND ENGINEER PRIOR TO ANY DEMOLITION WORK. - ALL SURFACES TO BE BROUGHT TO SAFE AND CLEAN CONDITION AFTER DEMOLITION OF ANY PARTITIONS, WALLS, FLOORS AND CEILINGS AND OTHER BUILDING COMPONENT

- ALL EXISTING STRUCTURE INCLUDING LOAD BEARING WALLS, BEAMS, RAFTERS, JOISTS, LINTELS, COLUMNS, FOUNDATIONS, AND FOOTINGS TO BE VERIFIED FOR THEIR STRUCTURAL STABILITY. ALL SHORTCOMINGS INCLUDING SIGNS OF DECAY, WROUGHT, PERMANENT BENDING, AND ANYTHING ELSE DEEMED TO NOT MEET CURRENT BUILDING CODE STANDARDS SHOULD BE REPAIRED AND BROUGHT IN COMPLIANCE. ALL STRUCTURAL ISSUES TO BE BROUGHT TO THE ATTENTION BUILDING DESIGN AND ENGINEER.

WALLS TO BE REMOVED AND DEMOLISHED UNLESS



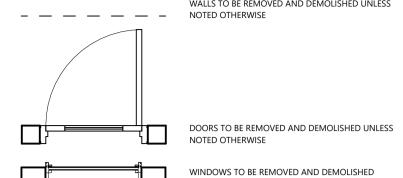

WINDOWS TO BE REMOVED AND DEMOLISHED UNLESS NOTED OTHERWISE

61 DEMOLISH WALL

62 DEMOLISH FLOOR 63 DEMOLISH ROOF

64 DEMOLISH STRUCTURE DEMOLISH BEAM, JOIST, COLUMN, FOUNDATION

65 DEMOLISH WINDOW / OPENING

66 FILL IN WALL / OPENING 67 DEMOLISH ELECTRICAL

69 SHORE STRUCTURE

DISCONNECT ELECTRICAL AND RELOCATE ELECTRICAL AND / OR ELECTRICAL PANEL

68 SAW CUT FLOOR FOR NEW PLUMBING / ELECTRICAL

PRIOR TO DEMOLISHING 70 DEMOLISH STAIRS


LOAD BEARING WALLS, FLOORS, AND ROOF TO BE SHORED WHERE APPLICABLE

STAIRS TO BE REMOVED AND CONTRACTOR TO PROVIDE TEMPORARY RAILING AROUND OPENING 71 SAFETY RAILING CONTRACTOR TO BUILD SAFTEY RAILINGS IN OPENINGS WHERE APPLICABLE

72 WALL TO BE ALTERED WALL TO BE ALTERED, EXTERIOR MATERIAL TO BE REMOVED, NEW OPENINGS TO BE PROVIDED.

(73) DEMOLISH FIREPLACE REMOVE FIREPLACE IN ITS ENTIRETY, PATCH ROOF AS REQUIRED

UNTIL AREA IS MADE CODE COMPLIANT

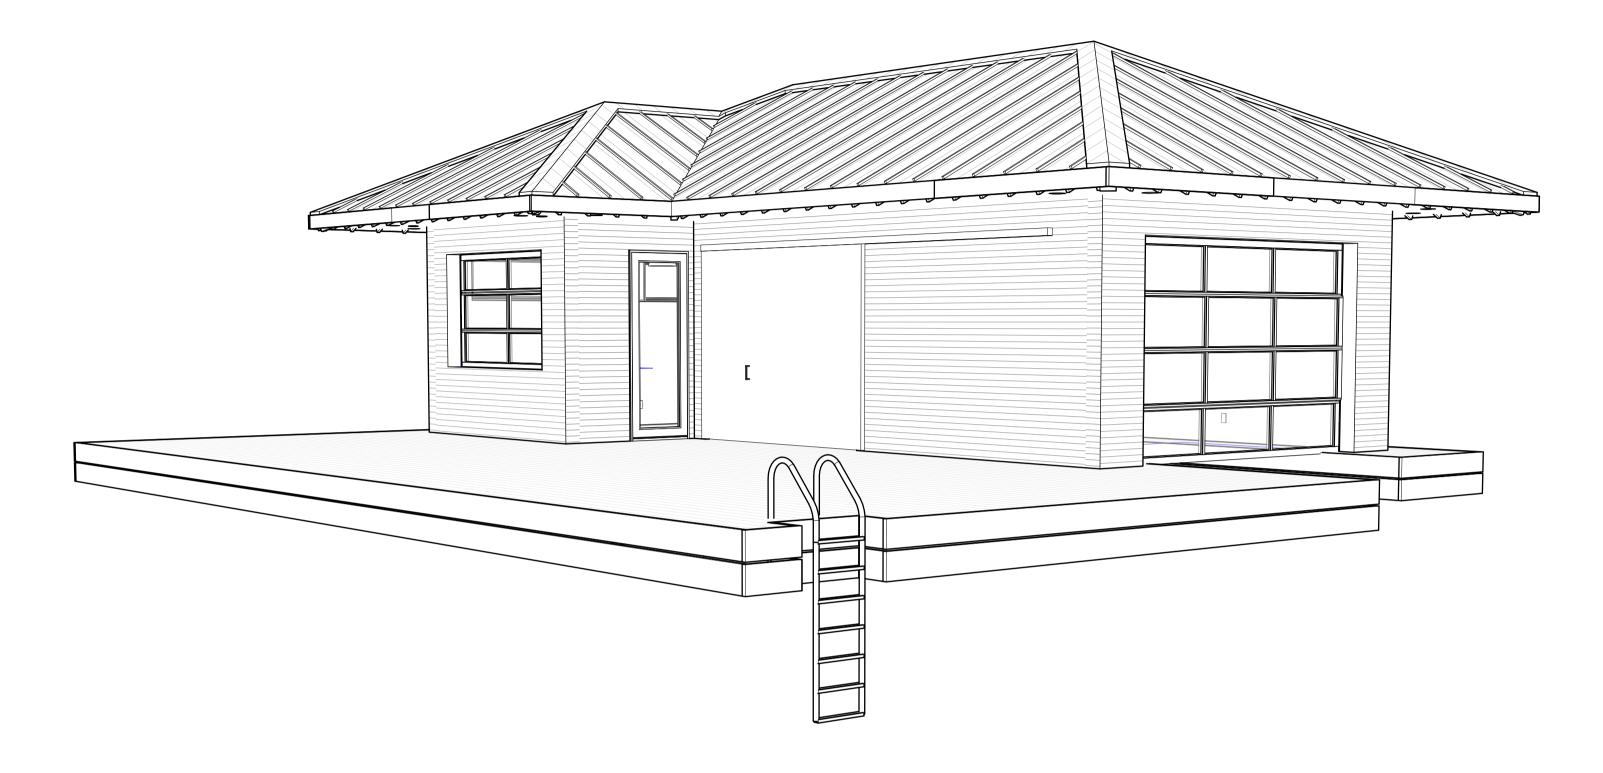

1150 HWY. #141, ROSSEAU, ON DESIGN@CORBINPATTEN.COM 877.562.1959

NT: DORACIN

JECT: BOATHOUSE

DORACIN

1182 ASHFORTH DR, MUSKOKA LAKES, ON

FOR INFORMATIONAL PURPOSES ONLY

LOCATION MAP



AREA

Area (SM) SITE AREA (OVERALL & FIRST 61M) 26270 SF 2440.54 m² EXISTING COTTAGE 1645 SF 152.80 m² PROPOSED BOATHOUSE 653 SF 60.63 m² PROPOSED GARAGE 286 SF 26.57 m² PROPOSED COTTAGE ADDITION 285 SF 26.46 m²

REVISION SCHEDULE

DATE DESCRIPTION 1 2021_0512 DESIGN APPROVAL 2 2021_0512 ISSUED FOR ENG. 3 2021_0811 ISSUED FOR DOCK PERMIT 4 2022_0105 ISSUED FOR BIDDING 5 2023_0531 ISSUED FOR BH. PERMIT

OWNER

FRANK AND ELIZABETH DORACIN 1182 ASHFORTH DRIVE, MUSKOKA LAKES, ON, POC 1M0 FRANK@DORACINTSL.COM

CONTRACTOR

TBD CONTACT

CORBIN PATTEN DESIGNS 1150 HWY. #141, ROSSEAU, ON 877.562.1959 DESIGN@CORBINPATTEN.COM CONTACT FRANK DORACIN CONTACT CORBIN PATTEN **ENGINEER**

DE KONING GROUP 3-3 LEE VALLEY DRIVE, PORT CARLING, ON, POB 1J0 705.646.3800 DEKONINGGROUP.COM CONTACT NICK DE KONING

BOATHOUSE

DESIGNER

SHEET LIST

SHEET NAME A000 COVER SHEET A001 NOTES AND LEGENDS A100 SITE PLAN A200 1ST FL. DOCK PLAN A201 1ST FL. BH & ROOF PLAN A300 N/S ELEVATIONS

A301 E/W ELEVATIONS A400 LONGITUDINAL SECTIONS A401 LATITUDINAL SECTIONS

A500 DETAILS E100 1ST FL. LIGHTING/POWER Grand total: 1

607 SF

0.00 CF

113' - 2"

Ceiling Finish 0.00 CF 113' - 2" 607 SF

NOT TO SCALE

GENERAL NOTES - PLANS

- ALL DIMENSIONS ARE TO THE EDGE OF THE STUD AND DO NOT INCLUDE FINISH MATERIALS. - ALL CONCRETE TO BE 24 MPa UNLESS SPECIFIED ON DRAWINGS.

5 EXTERIOR WALLS

EXTERIOR FINISH AS SPECIFIED.

1/2" STRAPPING TO BE FASTENED AND ALIGNED WITH STUDS SPACED AT 16"

AIR BARRIER 1/2" PRESSURE TREATED PLYWOOD SHEATHING

PRESSURE TREATED WALL STUDS TO BE SPACED AT 16" O.C. OR AS OTHERWISE

INSULATION REQUIRED AS PER WALL TYPE. BATT OR SPRAY FOAM INSULATION TO MEET DESIGN CRITERIA OR APPLICABLE CODES.

INTERIOR FINISH DOUBLE PLATE @ TOP AND SINGLE PRESSURE TREATED PLATE @ BOTTOM. WALLS TO BE BLOCKED HORIZONTALLY AT MID POINT

L1 = 2 - 2" X 6", 1- PLY BUILT-UP POST L2 = 3 - 2" X 6", 1- PLY BUILT-UP POST L3 = 2 - 2" X 8", 1- PLY BUILT-UP POST

L4 = 3 - 2" X 8", 1- PLY BUILT-UP POST L5 = 2 - 2" X 10", 1- PLY BUILT-UP POST L6 = 2 - 2" X 12", 2- PLY BUILT-UP POST L7 = 3 - 7 1/4" LVL, 2- PLY BUILT-UP POST

L8 = 3 - 9 1/2" LVL, 2- PLY BUILT-UP POST

L9 = 3- 11 7/8" LVL, 2- PLY BUILT-UP POST LINTELS OTHERWISE TO BE SPECIFIED BY ENGINEER OR TRUSS MANUFACTURER.

DOORS TO HAVE A BLACK EXTERIOR FINISH OR AS SPECIFIED BY DRAWINGS SPECIFICATION TO BE APPROVED BY OWNER AND BUILDING DESIGNER. ALL WINDOWS AND DOORS TO BE ALIGNED WITH THE TOPS AT THE SAME

SEE SCHEDULE

(21) WINDOWS WINDOWS TO HAVE A BLACK EXTERIOR AND BLACK INTERIOR FINISH OR AS SPECIFIED BY DRAWINGS DOUBLE PANEL, LOW-E, AND GAS FILLED.

SPECIFICATION TO BE APPROVED BY OWNER AND BUILDING DESIGNER. ALL WINDOWS AND DOORS TO BE ALIGNED WITH THE TOPS AT THE SAME SEE SCHEDULE

22 EXTERIOR DECKS

EXTERIOR DECKS TO BE 2 X 8 " CEDAR DECKING WITH 1/4" GAP.

RAILING TO BE 42" (1.07M) IN HEIGHT WITH DISTANCE ABOVE GRADE MORE THAN 71" (1.8M) OTHERWISE RAILING TO BE 35 1/2" (0.9M) IN HEIGHT. RAILING OPENINGS TO BE NOT MORE THAN 4" (0.1M)

 $\overline{\langle 27 \rangle}$ SMOKE ALARM AND CARBON MONOXIDE SMOKE ALARMS AND CARBON MONOXIDE DETECTORS TO BE INSTALLED ON EACH STOREY, INCLUDING BASEMENTS, AND TO BE LOCATED IN EACH SLEEPING ROOM OR A LOCATION BETWEEN THE SLEEPING ROOMS. SMOKE ALARMS SHALL BE WIRED SO THAT THE ACTIVATION OF ONE ALARM WILL CAUSE ALL ALARMS WITHIN THE DWELLING UNIT TO SOUND.

30 STONE OR BRICK VENEER

1.5" VENEER: VENEER TO BE INSTALLED WITH MORTAR ON REINFORCEMENT MESH. 1/2" CEDAR BREATHER TO BE USED AS AIR SPACE UNDER REINFORCING MESH. REINFORCEMENT MESH TO BE SCREWED TO CONCRETE BOARD. 4" STONE VENEER:

STONE VENEER TO ATTACH TO CONCRETE BLOCK WALL WITH METAL TIES @ 400mm (16") O.C. HORIZ., 600mm (24") O.C. VERTICAL

(33) HORIZONTAL SIDING 6" BEVEL HORIZONTAL WOOD SIDING, PAINT ALL SIDES

43 CABINETRY

CABINETRY AND MILLWORK AS PER DRAWINGS. UPPER CABINETRY LIGHTING TO BE COORDINATED WITH OWNER AND BUILDING DESIGNER.

BATHROOM VANITY AND MILLWORK AS PER CABINETRY MANUFACTURER'S LAYOUT, C/W FULL HEIGHT x VANITY WIDTH MIRROR. BATHROOM VANITY TO BE COORDINATED WITH OWNER AND BUILDING DESIGNER.

MANUFACTURER TO CONFIRM LOCATION OF APPLIANCES WITH OWNER AND BUILDING DESIGNER.

54 INTERIOR FINISH

TRIM TO BE APPROVED BY OWNER AND BUILDING DESIGNER. LINEN CLOSET PROVIDE 5 ADJUSTABLE WOOD SHELVES. CLOSET FINISH, ROD & SHELF, EXCEPT FOR MASTER BEDROOM WALK IN CLOSETS, WILL HAVE CUSTOM BUILT-INS TO LATER DETAIL.


59 MDF WALL CONSTRUCTION 1X8" T&G MDF WALL. WALL TO HAVE SQUARE NICKEL REVEAL.

WALL LEGEND

2X6 WOOD CONSTRUCTION EXTERIOR WALL

1" WOOD SIDING

1/2" STRAPPING 1/2" PRESSURE TREATED PLY WITH AIR BARRIER 5 1/2" PRESSURE TREATED STUD 5/8" INTERIOR FINISH

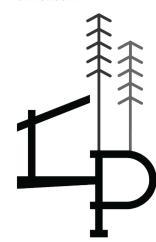

CORBIN PATTEN DESIGNS


1150 HWY. #141, ROSSEAU, ON DESIGN@CORBINPATTEN.COM 877.562.1959

DATE DESCRIPTION

2021 0512 ISSUED FOR FNG 2022 0105 ISSUED FOR RIDDING


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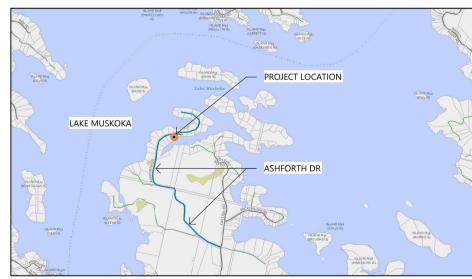


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NT: DORACIN

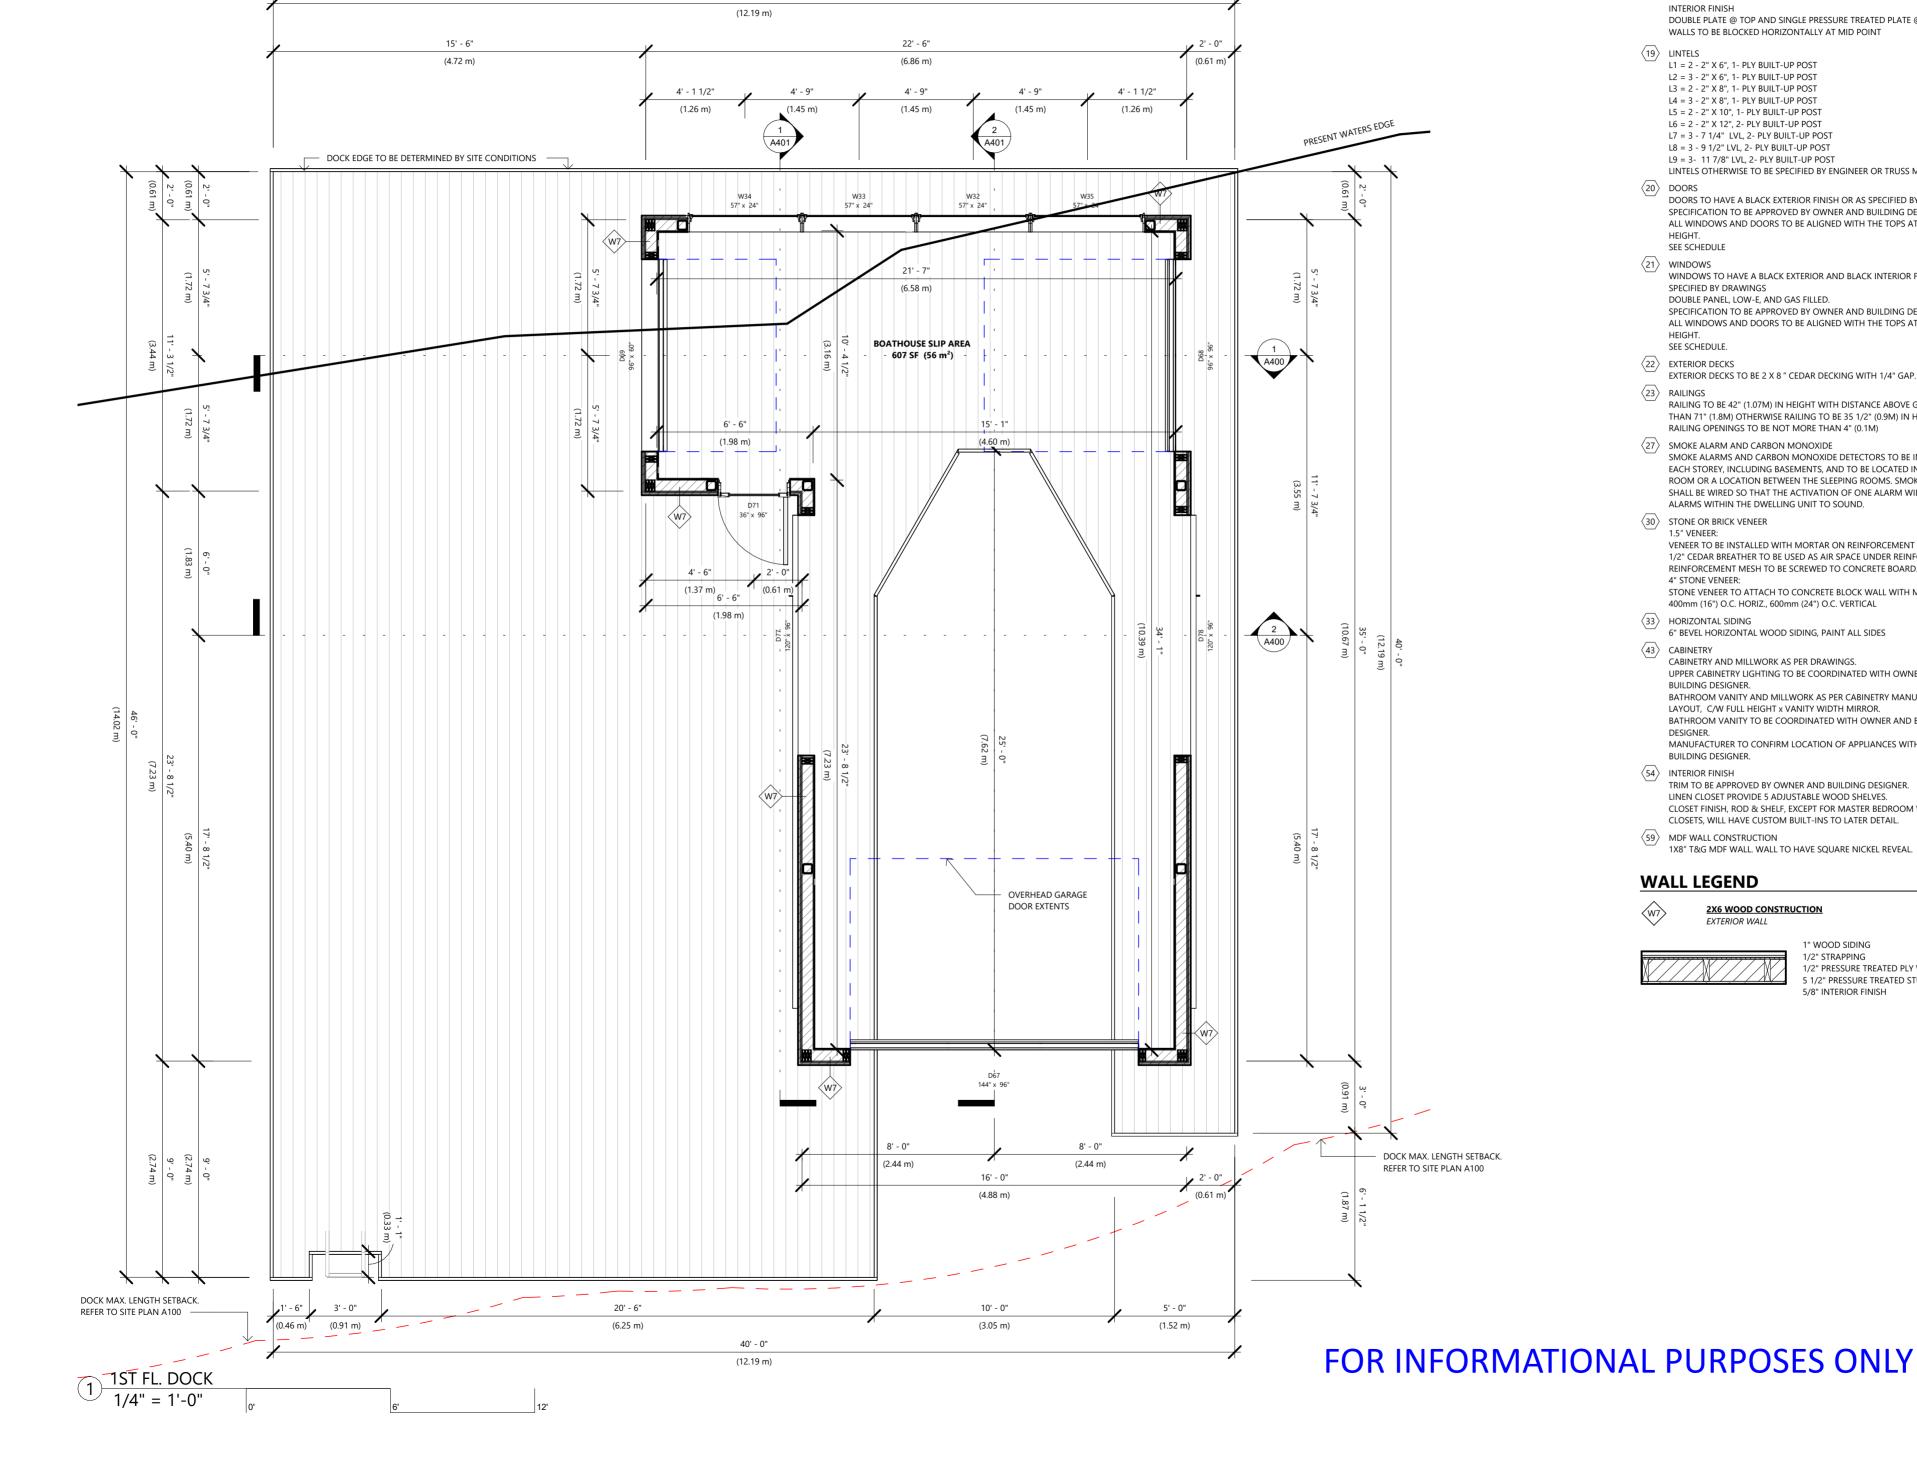

LOCATION MAP

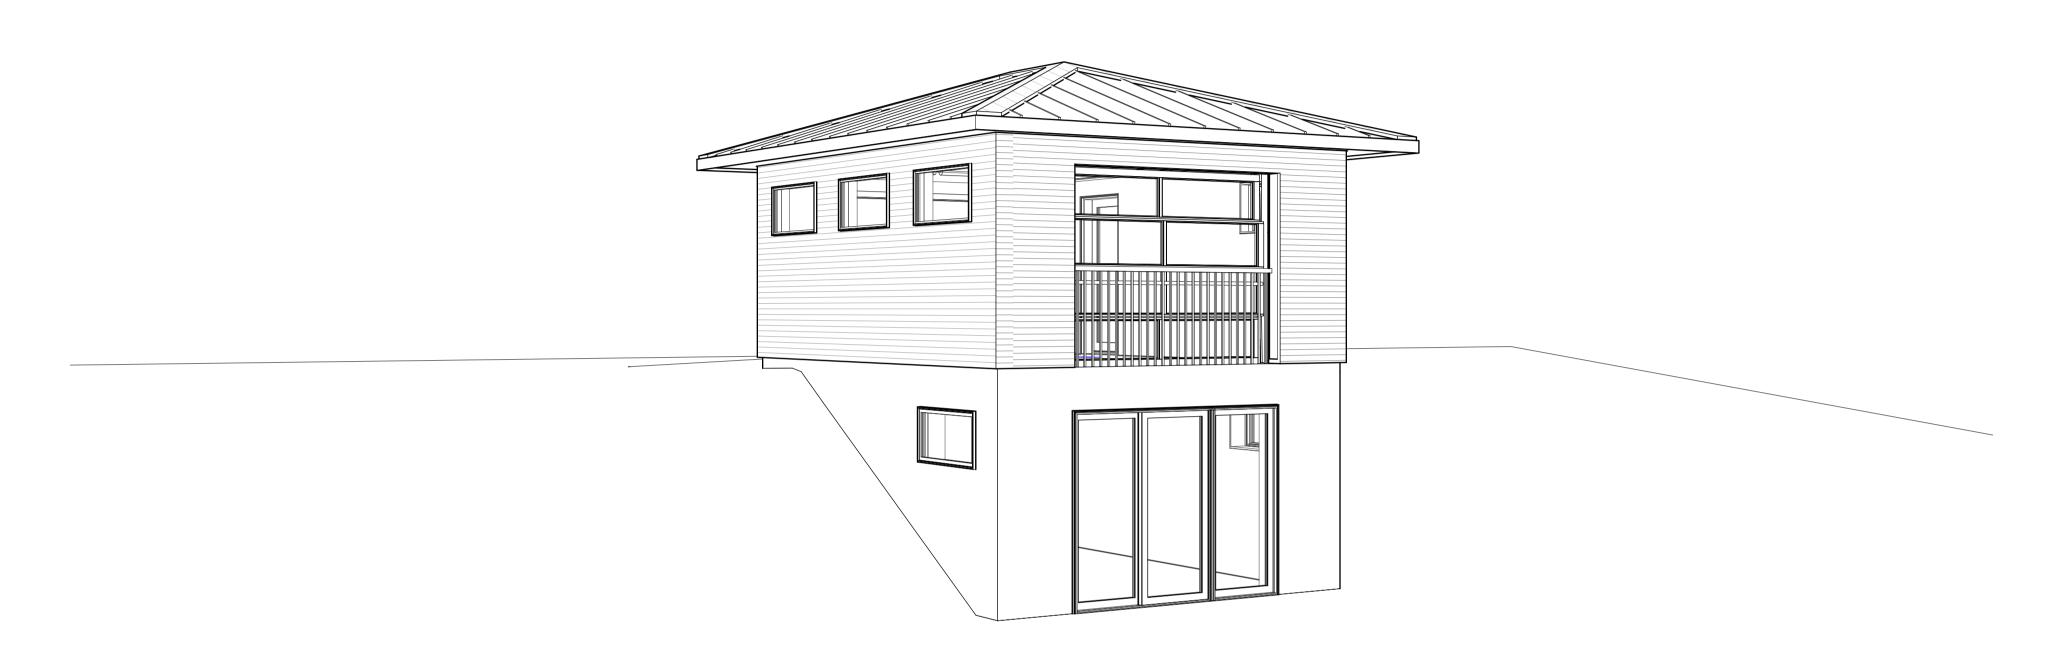

FOR INFORMATIONAL PURPOSES ONLY

SHEET LIST

SHEET LIST		SH	IEET LIST	SHEET LIS		
#	SHEET NAME	#	SHEET NAME	#	SHEET NAME	
A000	COVER SHEET					
A001	NOTES AND LEGENDS					
۸100	CITE DI ANI					

A200 PLAN A300 ELEVATIONS + 3D

E201 2ND FL. SWITCHING

A400 SECTIONS & DETAILS E100 BSMT. & 1ST POWER & DATA E101 2ND POWER & DATA E200 BSMT. AND 1ST. SWITCHING

Level Area Area (SM) SITE AREA (OVERALL & FIRST 1ST FL. 26270 SF 2440.54 m² EXISTING COTTAGE 1ST FL. 1645 SF 152.80 m² 1ST FL. 653 SF 60.63 m² PROPOSED BOATHOUSE PROPOSED GARAGE 1ST FL. 285 SF 26.48 m² PROPOSED COTTAGE ADDITION 1ST FL. 263 SF 24.41 m²

AREA

REVISION SCHEDULE

DATE DESCRIPTION 1 2022_0105 DESIGN APPROVAL 2 2023_0925 ISSUED FOR PERMIT

OWNER

FRANK AND ELIZABETH DORACIN 1182 ASHFORTH DRIVE, MUSKOKA LAKES, ON, POC 1M0 FRANK@DORACINTSL.COM CONTACT FRANK DORACIN

CONTRACTOR

CONTACT

TBD

DESIGNER

CORBIN PATTEN DESIGNS 1150 HWY. #141, ROSSEAU, ON 877.562.1959 DESIGN@CORBINPATTEN.COM CONTACT CORBIN PATTEN


ENGINEER

DE KONING GROUP INC. 3 ARMSTRONG POINT RD., PORT CARLING, ON, POB 1J0 705.640.3800 NICK@DEKONINGGROUP.COM CONTACT NICHOLAS DE KONING

GARAGE

1182 ASHFORTH DR, MUSKOKA LAKES, ON

DORACIN

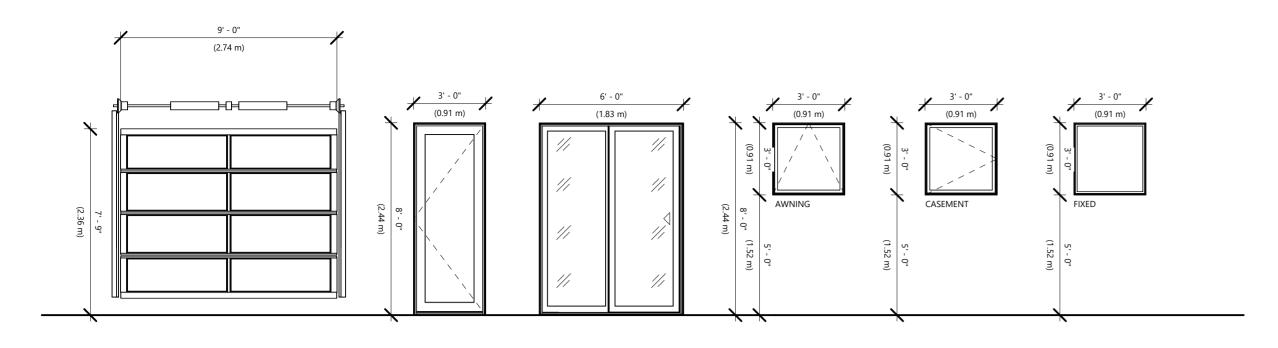

Sill Height Rough Width Rough Height

2' - 0 3/4"

2' - 0 3/4"

2' - 0 3/4"

2' - 0 3/4"

2' - 0 3/4"

2' - 0 3/4"

4' - 0 3/4"

4' - 0 3/4"

4' - 0 3/4"

4' - 0 3/4"

4' - 0 3/4"

4' - 0 3/4"

NOT TO SCALE

GENERAL NOTES - FRAMING

- GENERAL NOTES:
 ALL DIMENSIONS ARE TO THE EDGE OF THE STUD AND DO NOT INCLUDE FINISH MATERIALS.
- SITE SNOW LOAD: 60 PSF (TRUSS SUPPLIER TO CONFIRM)
- ALL GABLE ENDS, LADDERS AND DORMERS WALLS ARE TO BE SITE FRAMED UNLESS
- TRUSS SUPPLIER DRAWINGS SUPERCEDE ARCHITECTURAL ROOF & TRUSS DRAWINGS

WALL LEGEND

8" POURED CONCRETE W/ INTERIOR STUD FOUNDATION WALL


DRAINAGE BOARD (BELOW GRADE) OR SIDING (A.F.G.) 8" RIENFORCED CONCRETE WALL 3 1/2" STUD WITH BLOWN IN BATT INSULATION



2X6 WOOD CONSTRUCTION EXTERIOR WALL

15' - 0"

1" WOOD SIDING 1/2" STRAPPING 1/2" PLY WITH AIR BARRIER 5 1/2" STUD WITH BLOWN IN BATT INSULATION SMART VAPOUR BARRIER 5/8"INTERIOR FINISH

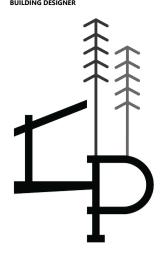

CORBIN PATTEN DESIGNS


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DATE DESCRIPTION
1 2022_0105 DESIGN APPROVAL
2 2023_0925 ISSUED FOR PERMIT

GARAGE NT: DORACIN CLIE PRO

DOOR SCHEDULE - EXTERIOR

#	Description	Rough Width	Rough Height	Area	Level
68	Door-Slider-3_Panel:9' - 0" X 7' - 0"	9' - 0 3/4"	7' - 0 3/4"	64 SF	BSMT.
70	Door-In-Swing-Single:3' - 0" X 7' - 0"	3' - 0 3/4"	7' - 0 3/4"	22 SF	1ST FL.

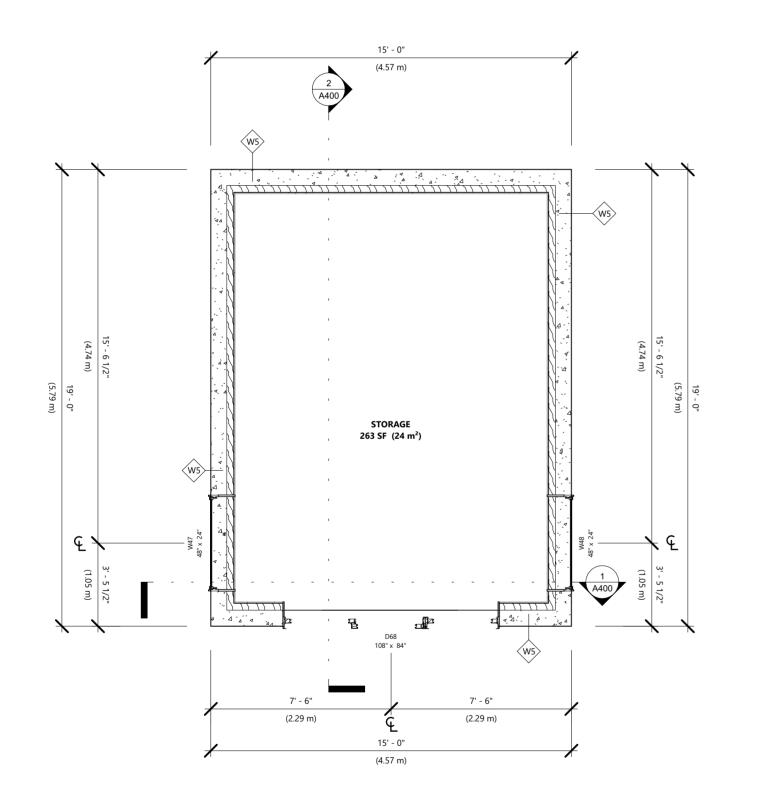


70' - 10"


BSMT.

1ST FL.


1ST FL.

1ST FL.

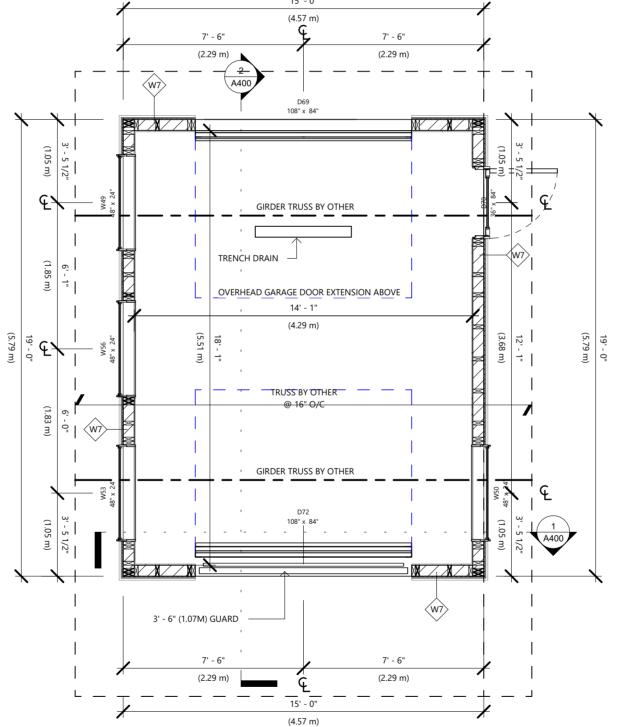

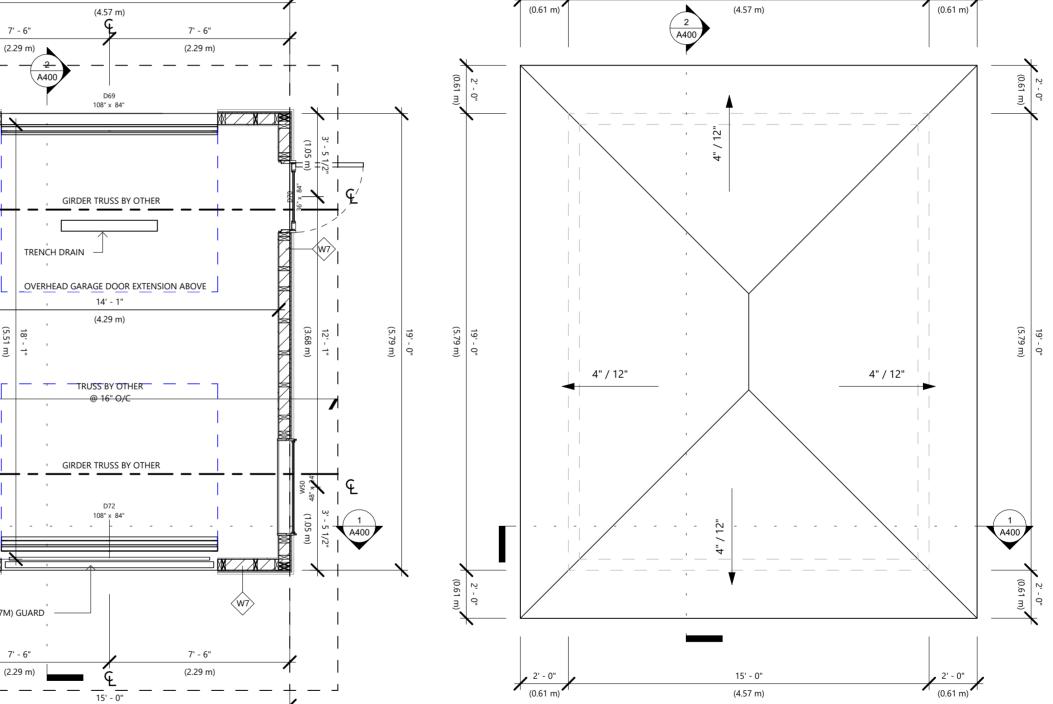



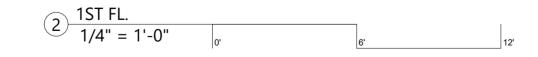

7.O.R.			
1/4" = 1'-0"	0'	6'	12'

ROOM SCHEDULE - BSMT. FINISH

ROOM SCHEDULE - DSMI, HMISH									
Name	Level	Area	Volume	Perimeter	Height	Wall Finish	Floor Finish	Ceiling Finish	Base Finish
STORAGE	BSMT.	263 SF	Not Computed	70' - 10"	8' - 0"				
		262 CE	0.00 CE	70' 10"					

ROOM SCHEDULE - LEVEL 1

Grand total: 1

WINDOW SCHEDULE

47 Window-Awning: 4' - 0" X 2' - 0"

48 Window-Awning: 4' - 0" X 2' - 0"

49 Window-Fixed: 4' - 0" X 2' - 0"


50 Window-Fixed: 4' - 0" X 2' - 0"

53 Window-Fixed: 4' - 0" X 2' - 0" 56 Window-Fixed: 4' - 0" X 2' - 0"

Name	Level	Area	Area M2
GARAGE	1ST FL.	270 SF	25 m ²
		270 SF	25 m ²
Grand total: 1		270 SF	25 m ²

263 SF

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GENERAL NOTES - ELEVATIONS

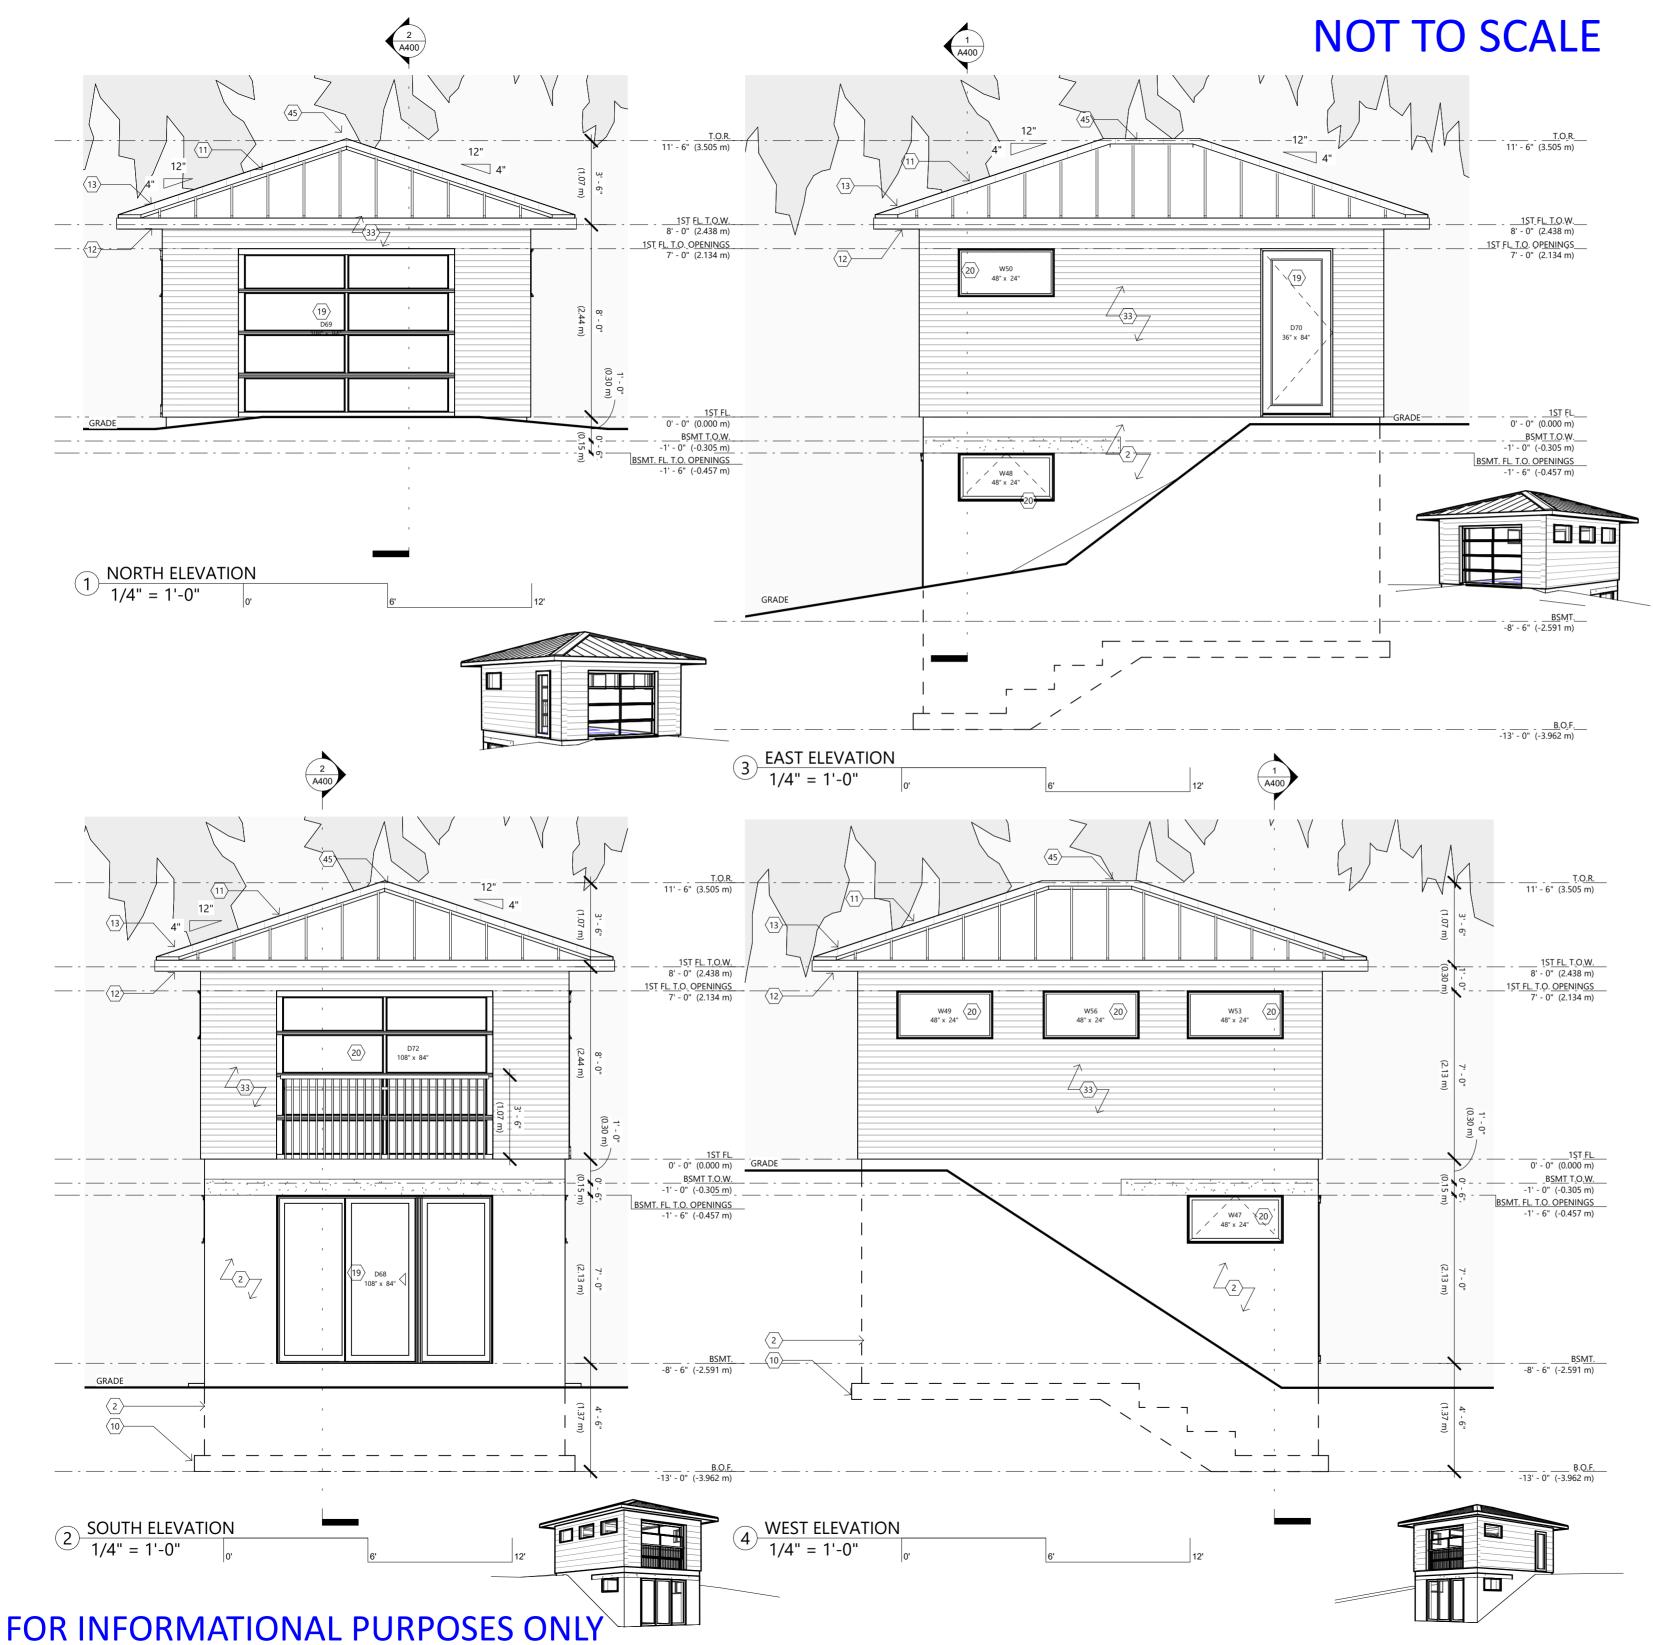REFER TO A001 FOR CODED NOTE DESCRIPTIONS

CODED NOTES - ELEVATIONS

REFER TO A001 FOR CODED NOTE DESCRIPTIONS

POURED FOUNDATION WALL
DRAINAGE BOARD (BELOW GRADE) OR SIDING (ABOVE GRADE) 8" REINFORCED CONCRETE WALL

WHERE FOUNDATION IS BELOW GRADE, DRAINAGE BOARD ON WATERPROOF 5/8" (15M) REINFORCEMENT @ 12" VERTICAL AND HORIZONTAL PER ENGINEER

STUD ON FOUNDATION WALL INTERIOR FOUNDATION WALL AS PER NOTE. 1/2" SPACE BETWEEN STUD AND CONCRETE WALL

3 1/2" STUD WITH SPRAY FOAM INSULATION INTERIOR FINISH AS PER DRAWINGS OR AS SPECIFIED BY BUILDING DESIGNER AND

2X6 EXTERIOR WALL EXTERIOR FINISH AS SPECIFIED.

1/2" STRAPPING TO BE FASTENED AND ALIGNED WITH STUDS SPACED AT 16" O/C. EXTERIOR RIGID FOAM AS PER DRAWINGS, AMVIC SILVERBOARD RIGID FOAM INSULATION TO BE PLACED ON EXTERIOR OF SHEATHING TO ACT AS AIR BARRIER AND AIR BARRIER

1/2" OSB OR PLYWOOD

5 1/2" WALL STUDS TO BE SPACED AT 16" O/C OR AS OTHERWISE SPECIFIED. INSULATION REQUIRED AS PER WALL TYPE. BATT OR SPRAY FOAM INSULATION TO MEET DESIGN CRITERIA OR APPLICABLE CODES.

INTERIOR FINISH ADDITIONAL NOTES:

DOUBLE PLATE @ TOP AND SINGLE PLATE @ BOTTOM.

EXTERIOR RIGID INSULATION

- CONTINUOUS RIGID FOAM INSULATION TO ACT AS AIR BARRIER AND TO BE TAPED AT 1" AMVIC SILVERBOARD RIGID INSULATION OR 1.5" ZIP R SHEATHING (1/2" OSB WITH 1" RIGID FOAM) TO BE DEFAULT EXTERIOR INSULATION OR AS SPECIFIED BY DRAWINGS.
- ALL FOOTINGS TO REST ON UNDISTURBED SOIL, ROCK OR COMPACTED GRANULAR FILL. FOUNDATION WALL FOOTINGS: REINFORCED CONCRETE FOOTING SIZE AS SPECIFIED BY ENGINEER.

PREFINISHED WOOD FOR SOFFIT FASCIA, TO MATCH EXISTING FINISHES. PROVIDE DRIP

- ROOF CONSTRUCTION
- FINISHING ROOFING TYPE AS PER SPECIFICATION. ROOF TRUSSES SPECIFIED BY TRUSS MANUFACTURER
- OVERHANG CONSTRUCTION
- EDGE AT FASCIA AND SOFFIT VENT. **EAVES PROTECTION**
- EAVES PROTECTION MEMBRANE TO EXTEND FROM THE EDGE OF THE ROOF, 60" UP THE SLOPE BUT NOT LESS THAN 36 " BEYOND THE INTERIOR FACE OF THE
 - DOORS TO HAVE A BLACK EXTERIOR FINISH OR AS SPECIFIED BY DRAWINGS SPECIFICATION TO BE APPROVED BY BUILDING DESIGNER AND OWNER. ALL WINDOWS AND DOORS TO BE ALIGNED WITH THE TOPS AT THE SAME HEIGHT. SEE SCHEDULE ADDITIONAL NOTES:

DOOR INTO GARAGE TO BE GAS PROOFED WITH SELF CLOSER AND WEATHER STRIPPING. FOUNDATION WALLS TO BE CUT OUT FOR OVERHEAD DOOR, OR MAN DOOR ABOVE.

WINDOWS TO HAVE A BLACK EXTERIOR FINISH OR AS SPECIFIED BY DRAWINGS DOUBLE PANEL, LOW-E, AND GAS FILLED. SPECIFICATION TO BE APPROVED BY BUILDING DESIGNER AND OWNER. ALL WINDOWS AND DOORS TO BE ALIGNED WITH THE TOPS AT THE SAME HEIGHT. SEE SCHEDULE.

HORIZONTAL SIDING


6" BEVEL HORIZONTAL WOOD SIDING, PAINT ALL SIDES

ROOF VENTING


CONTINUOUS VENTING TO PROVIDED AT RIDGE AND EAVE. MIN. 1.5" AIR SPACE TO PROVIDED ON THE U/S OF SHEATHING FOR VENTILATION.

ROOF LEGEND

METAL ROOF SLOPED CEILING, FINISHED

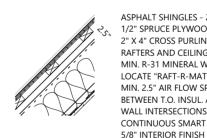

ASPHALT SHINGLES - 25 YEAR 1/2" SPRUCE PLYWOOD + 'H' CLIPS ON, 2" X 4" CROSS PURLINS FOR VENTILATION RAFTERS AND CEILING JOISTS AS PER PLANS MIN. R-31 MINERAL WOOL BATT INSULATION LOCATE "RAFT-R-MATE" ATTIC RAFTER VENTS TO ENSURE MIN. 2.5" AIR FLOW SPACE BETWEEN T.O. INSUL. AND B.O. PURLINS AT RAFTER-TO-WALL INTERSECTIONS CONTINUOUS SMART VAPOUR BARRIER

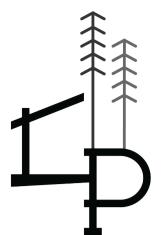

CORBIN PATTEN DESIGNS

1150 HWY. #141, ROSSEAU, ON DESIGN@CORBINPATTEN.COM 877.562.1959

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GARAGE NT: DORACIN JECT: CLE PRO

ELEVATIONS PERMIT SET