

Box 129, Port Carling, ON, POB 1JO Telephone (705) 765-3156 Fax (705) 765-6755

THE CORPORATION OF THE TOWNSHIP OF MUSKOKA LAKES

COMMITTEE OF ADJUSTMENT

FILE # A-27/23 ROLL # 2-9-029

NOTICE OF PUBLIC HEARING OF APPLICATION FOR MINOR VARIANCE

Planning Act, R.S.O., 1990, c.P.13,45(5), R.R.O., 1980, Reg. 787

APPLICATION MADE BY: Wendy Armstrong-Gibson, 80182 Front Road, Clinton, ON

N0M 1L0

LOCATION OF PROPERTY: Part Lot 30, Concession 4, Parts 2 to 4, Plan RP 35R-21268

(Watt), Civic Address: 1090 Boyce Road, Zoning Schedule: 30

EXPLANATION OF THE PURPOSE AND EFFECT: The subject property is zoned Waterfront Residential – Backlot (WR2) and Rural – Area 1 (RU1) and abuts Boyce Road.

The applicants propose to demolish an existing one storey dwelling and propose to construct a new one storey dwelling with a walk out basement and additions (including porches). The applicants also propose to construct a new sundeck.

Relief is requested from Sections 4.1.3 and 4.1.3.5 of By-law 2014-14, as amended, being the minimum front yard setback requirement for a dwelling addition. In this case, the required front yard setback is the front yard setback of the existing dwelling or a minimum of 50 feet, whichever is greater. The existing dwelling has a front yard setback of 40.2 feet (at the closest point), and therefore, the minimum front yard setback is 50 feet. A new addition (porch component) is to be set back 34 feet (at the closest point) from the front lot line. The requested variance is 16 feet.

Relief is also requested from Section 4.1.3 of By-law 2014-14, as amended, being the minimum interior side yard setback requirement of 15 feet for a dwelling. The proposed dwelling, including a new addition, is to be set back 11 feet (at the closest point) from the southerly side lot line. The requested variance is 4 feet. Please note that the existing dwelling is set back 11.6 feet (at the closest point) from the southerly side lot line.

Relief is also requested from Section 4.1.3 of By-law 2014-14, as amended, being the minimum interior side yard setback requirement of 15 feet for a sundeck. The proposed sundeck is to be set back 7 feet (at the closest point) from the southerly side lot line. The requested variance is 8 feet.

NOTICE: This notice has been sent to you for your information and does not require any response unless you wish to make one. The above noted application will be heard by the Committee of Adjustment on the date and at the time shown below.

DATE: June 12, 2023 TIME: 9:00 A.M.

TAKE FURTHER NOTICE THAT this public hearing will be held in a hybrid forum with electronic ZOOM participation, and in-person format for those wish to attend in person. The meeting will be held in the Council Chambers, Municipal Office, 1 Bailey Street, Port Carling, Ontario, and will commence at 9:00 a.m. More information about viewing and/or participating in the ZOOM hearing is included in this Notice and can be found on our website at www.muskokalakes.ca.

PUBLIC HEARING: You or your representative are entitled to participate in this public hearing and make verbal representation and/or make written representation prior to the meeting. This representation can be in support of or in opposition to the proposed Minor Variance. If you wish to make written comments on this application they may be forwarded to the Secretary - Treasurer at the email address shown below.

Members of the public may also observe the proceedings by accessing the live webcast at: <u>www.muskokalakes.ca</u> If the live webcast fails, the meeting recording will be posted at: https://muskokalakes.civicweb.net/Portal/

ADDITIONAL INFORMATION: There may be additional information relating to the proposed variance application available from staff of the Planning Department through the email address below on week days between 8:15 a.m. and 4 p.m. or by mail at The Corporation of the Township of Muskoka Lakes, Box 129, Port Carling, Ontario, P0B 1J0. Telephone: (705)765-3156 or FAX (705)765-6755. Please email any submissions or requests to: planning@muskokalakes.ca Please quote the Committee's file number noted above.

FAILURE TO PARTICIPATE IN HEARING: If you do not participate in the hearing it may proceed in your absence and, except as otherwise provided in the Planning Act, you will not be entitled to any further notice in the proceedings.


NOTICE OF DECISION: If you wish to be notified of the decision of the Committee of Adjustment in respect of this application, you must submit a written request to the Committee of Adjustment.


PLEASE NOTE: THE COMMITTEE OF ADJUSTMENT IS A JUDICIAL BODY WHICH MAKES DECISIONS SOLELY ON INFORMATION GATHERED AS A COMMITTEE. COMMITTEE MEMBERS ARE NOT TO BE CONTACTED PRIOR TO THE HEARING DATE TO AVOID A CONFLICT OF INTEREST.

Dated this 30th day of May, 2023.

"Original Signed by K. Bavington"
Kitty Bavington
Secretary-Treasurer
Committee of Adjustment

KEY MAP

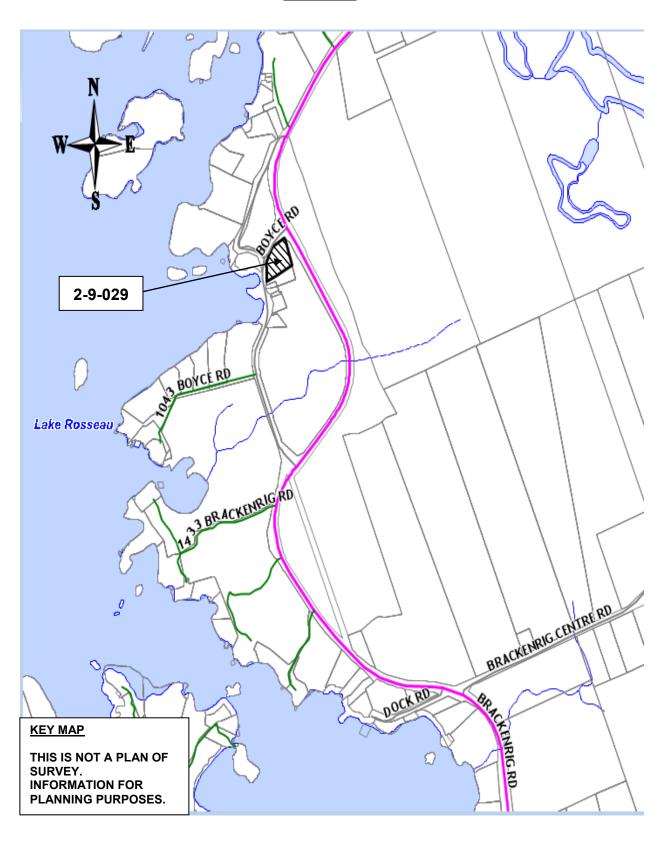

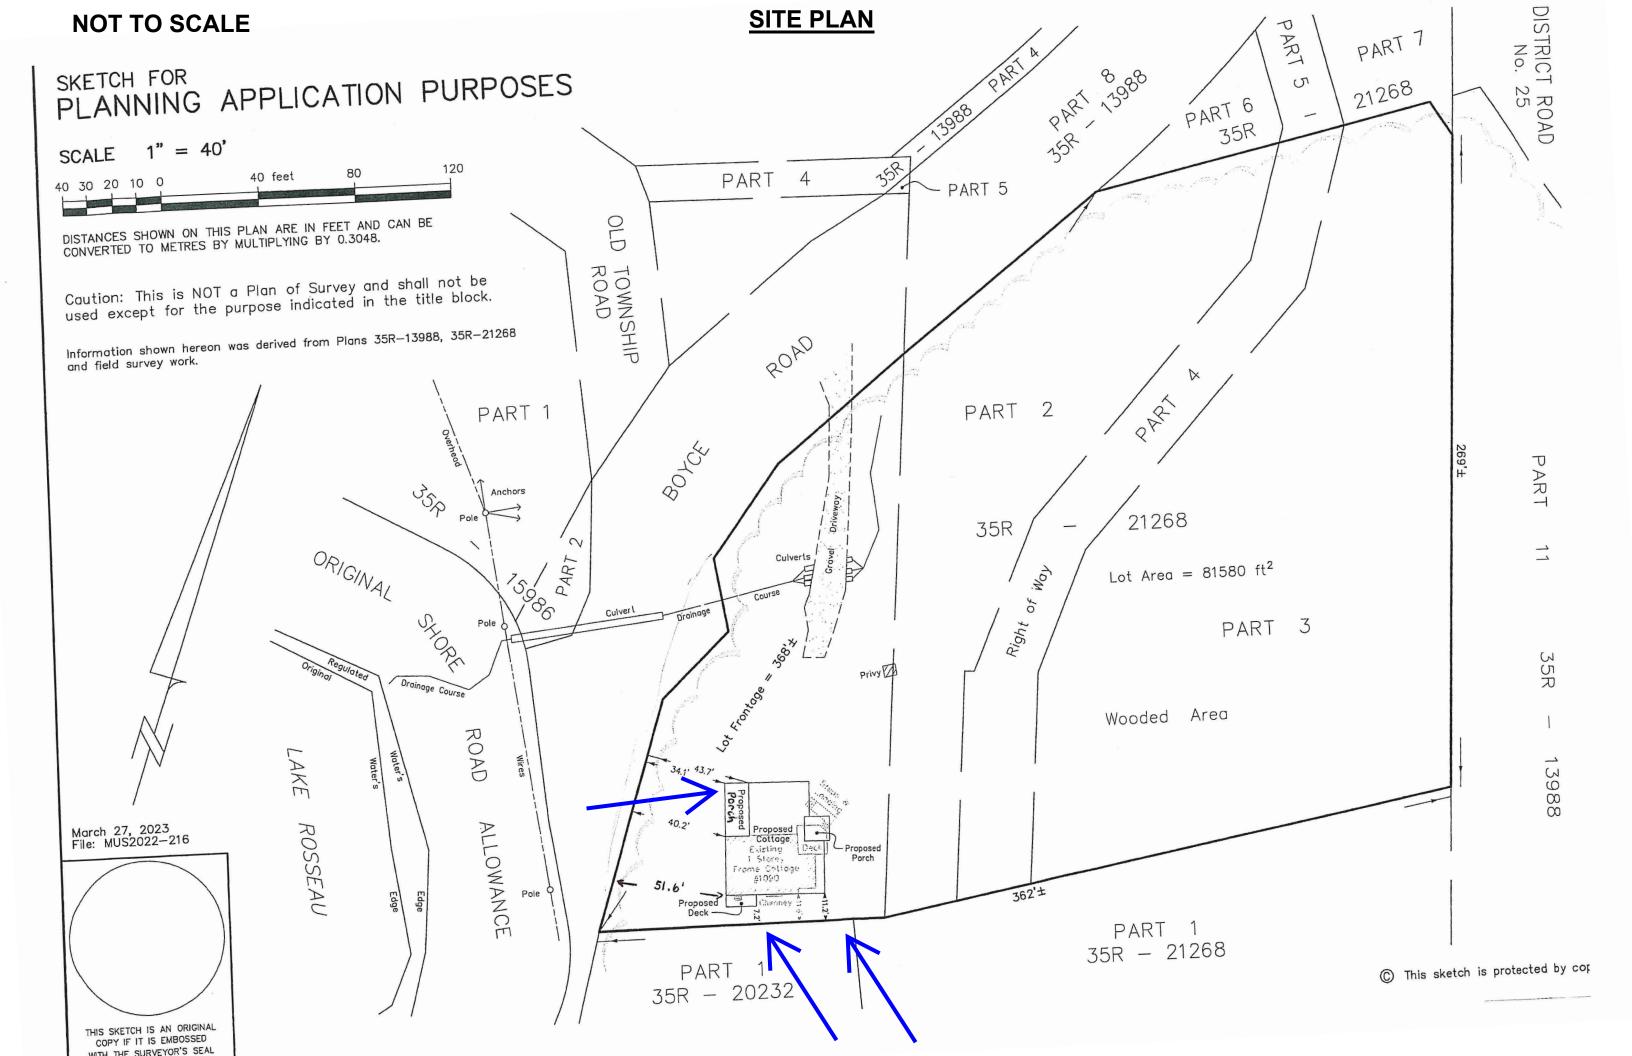



JOHN & WENDY GIBSON

1611 SQ' FT. COTTAGE

Energy Efficiency Design Summary: Prescriptive Method

Other Building Characteristics

(Building Code Part 9, Residential)

□ ICF Basement

This form is used by a designer to demonstrate that the energy efficiency design of a house complies with the building code using the prescriptive method described in Subsection 3.1.1. of SB-12. This form is applicable where the ratio of gross area of windows/sidelights/skylights/glazing in doors and sliding glass doors to the gross area of peripheral walls is not more than 22%.

	For use by	y Principal Au	thority		
Application No:		Model/C	ertification Number		
A. Project Information	JOHN & WEN	DY GIBSO)N		
Building number, street name				Unit number	Lot/Con
	CE ROAD, PORT CAR				
Municipality	Postal code	Reg. Pla	n number / other descr	ption	•
MUSKOKA LAKES DISTRICT POB 1J0					
B. Prescriptive Compliance [indicate the building code compliance package being employed in this house design]					
SB-12 Prescriptive (input design	package): Package:_	A5	Tab	ole: 3.1.1.2.A (I	<u>P</u>)
C. Project Design Condition	S				
Climatic Zone (SB-1):	Heating Equipment E	fficiency	Space Heating	Fuel Source	
X Zone 1 (< 5000 degree days) X Zone 1 (< 5000 degree days)	★ ≥ 92% AFUE		□ Gas	★ Propane	□ Solid Fuel
□ Zone 2 (≥ 5000 degree days)	□ ≥ 84% < 92% AFUE		□ Oil	□ Electric	□ Earth Energy

		☐ Log/Post&Beam ☐ ICF Above Grade	
Area of walls = $247.4 \text{ m}^2 \text{ or } 2663 \text{ ft}^2$	W.S&G% = 16.8	□ Slab-on-ground ★Walkout Basement	
	VV, 0 & C /6 =	□ Air Conditioning □ Combo Unit	
	Utilize window averaging: □Yes □No	☐ Air Sourced Heat Pump (ASHP)	
Area of W, S & G = $_{1.5}$ m ² or $_{446.4}$ ft ²	- J	☐ Ground Sourced Heat Pump (GSHP)	
D. Building Specifications [provide values and ratings of the energy efficiency components proposed]			

2. During epochications (provide values and ratings of the chorgy emissions) con	ipononto propoced
Energy Efficiency Substitutions	

	Building Compone	nt	Minimu	m RSI / R values	Building Component	Efficiency Batings
ľ	,			Required:	Permitted Substitution:_	
(R	Airtightness test required efer to Design Guide Attached)	□ Table	3.1.1.4.C	Required:	Permitted Substitution:_	
		□ Table	3.1.1.4.B	Required:	Permitted Substitution:_	
	Airtightness substitution(s)					
	Combined space heating a	nd dome	stic water	heating systems (3.1.1.2.(7) / 3.1.1.3.(7))	
	□ ICF (3.1.1.2.(5) & (6) / 3.1.1.3.(5) & (6))					

	Rec	quired:	Permitted Substitution:_	
Building Component		SI / R values n U-Value ⁽¹⁾	Building Component	Efficiency Ratings
Thermal Insulation	Nominal	Effective	Windows & Doors Provide U-Value ⁽¹⁾ or ER	rating
Ceiling with Attic Space	R50	R49.23	Windows/Sliding Glass Doors	MAX. U 0.28
Ceiling without Attic Space	R31	R27.65	Skylights/Glazed Roofs	N/A
Exposed Floor	R35	R32.02	Mechanicals	
Walls Above Grade	R19 + 5 ci	R20.32	Heating Equip.(AFUE)	94%
Basement Walls Note (6): R12 +	5ci R20 ci	R15.96	HRV Efficiency (SRE% at 0°C)	70%
Slab (all >600mm below grade)			DHW Heater (EF)	.80
Slab (edge only ≤600mm below grade)	R10		DWHR (CSA B55.1 (min. 42% efficiency))	# Showers_1_
Slab (all ≤600mm below grade, or heat	ted) R10	R11.13	Combined Heating System	

(1) U value to be provided in either W/(m²•K) or Btu/(h•ft²•F) but not both.

Ratio of Windows, Skylights & Glass (W, S & G) to Wall Area

E. Designer(s) [name(s) & BCIN(s), if applicable, of person(s) providing information herein to substantiate that design meets the building code]

Qualified Designer Declaration of designer to have reviewed and take	responsibility for the design w	ork.
Name	BCIN	Signature
DUANE BAUMAN	28073	Deang Barmon

	DUANE BAUMAN	28073	Leany
Fo	orm authorized by OHBA, OBOA, LMCBO. Revised December 1, 2016.		

DRAWING SCHE	DRAWING SCHEDULE		
INDEX OF DRAWINGS	PAGE #		
COVER PAGE	A1.1		
PLAN PAGES			
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BASEMENT PLAN	A2.2		
MAIN FLOOR PLAN	A2.3		
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ELEVATIONS			
N & E ELEVATIONS	A3.1		
S & W ELEVATIONS	A3.2		
SECTION & DETAIL			
BUILDING SECTION	A4.1		
CONST. DETAILS	A4.2		
NOTES			
NOTES	A5.1		

AREA SCHEDULE		
NAME	AREA	
MAIN FLOOR AREA	1440 sq ft.	
BASEMENT FLOOR AREA	934 sq ft.	
FOUNDATION FOOTPRINT	1682 sq ft.	
MUSKOKA ROOM	171 sq ft.	
COVERED DECK	344 sq ft.	
COVERED ENTRY	93 sq ft.	
DECK	63 sq ft.	



I review and take responsibility for the design work on behalf of Star Blueprints Inc. I am qualified and the firm is registered in the appropriate classes.

BCIN 32267 This drawing is only valid for



REVISION SCHEDULE			
DATE	REVISION NOTE		
OCT 2, 2020	ISSUED FOR CLIENT REVIEW		
OCT 6, 2020	FDN PLAN REVISION PER SITE CONDITIONS		
OCT 9, 2020	FDN REVISION-WALL OFFSET BELOW DECK		
OCT 23, 2020	BASEMENT, MAIN BATH & KITCHEN REVISION		
NOV 05, 2020	ISSUED FOR PRELIMINARY TRUSS DRAWINGS		
NOV 09, 2020	CHANGE MAIN ROOF TO GABLED ENDS		
SEP 20, 2021	ISSUED FOR PERMIT		

NOV 15, 2021 REISSUED FOR PERMIT

JOHN & WENDY GIBSON


1611 SQ' FT. COTTAGE

1090 BOYCE ROAD PORT CARLING, ON P0B 1J0

COVER PAGE

SCALE:	As Noted	F
DATE:(Y/M/D)	2021-11-15	
DRAWN BY:	M. FREY	

A1.1

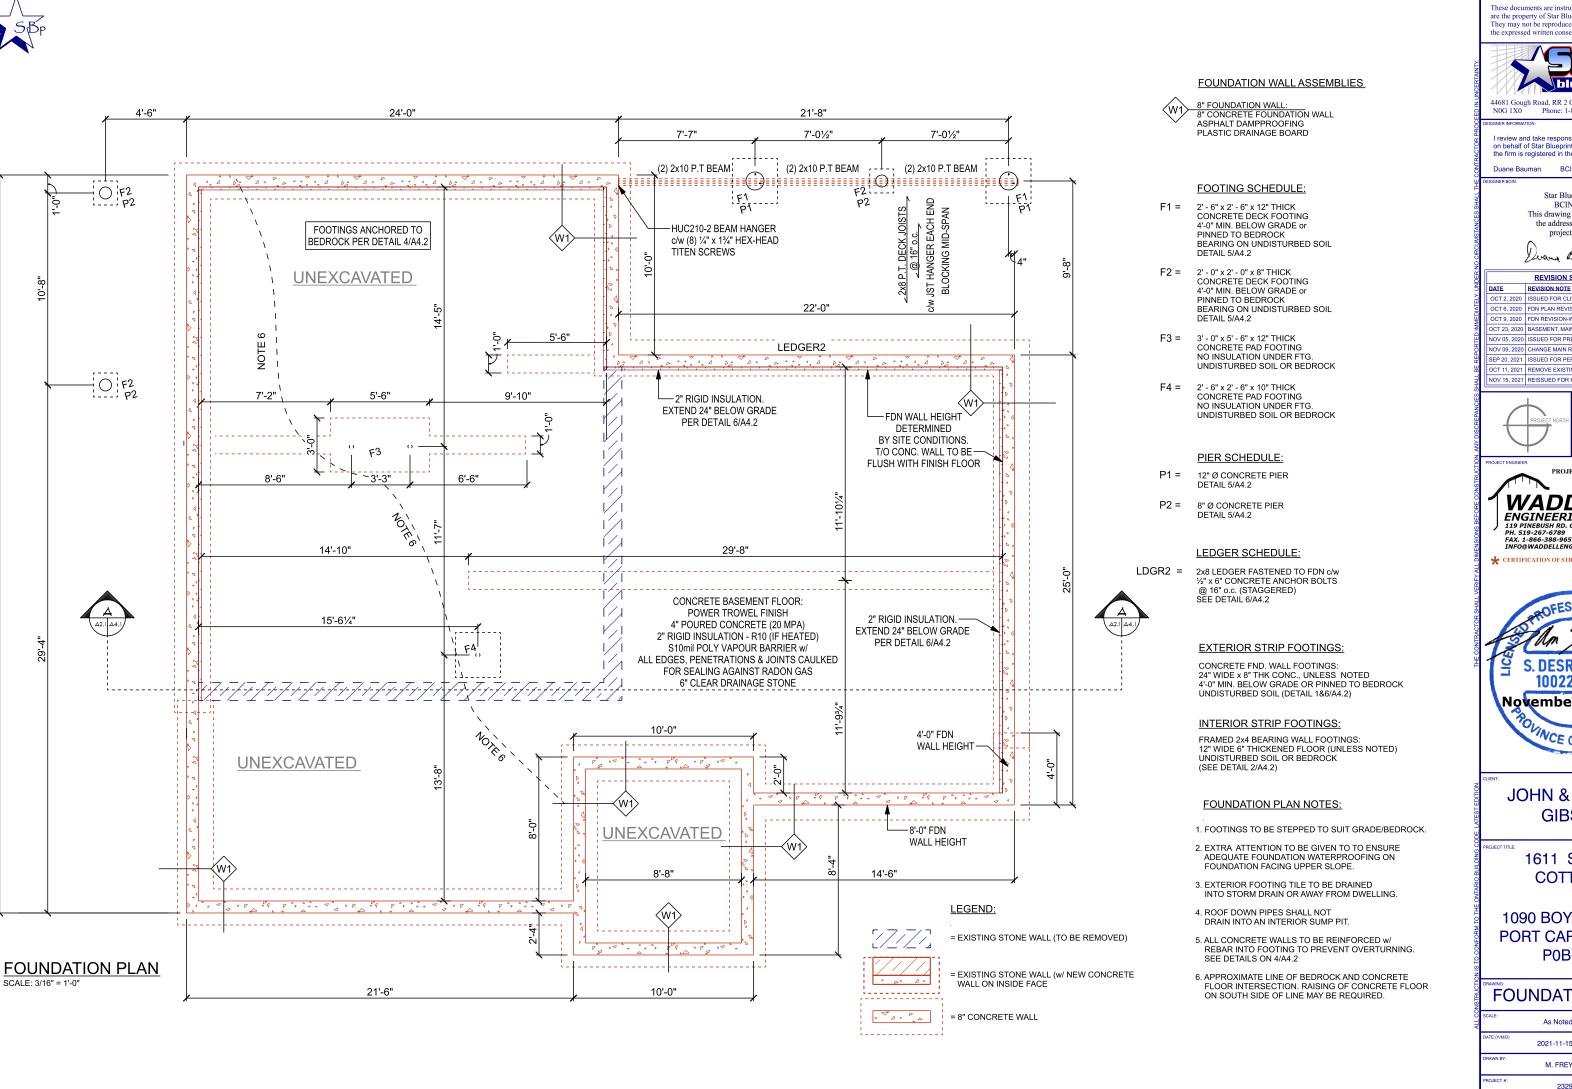



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BCIN 28073

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REVISION SCHEDULE REVISION NOTE OCT 9, 2020 FDN REVISION-WALL OFFSET BELOW DECK

NOV 05, 2020 ISSUED FOR PRELIMINARY TRUSS DRAWI NOV 09, 2020 CHANGE MAIN ROOF TO GABLED ENDS

OCT 11, 2021 REMOVE EXISTING STONE FDN WAL NOV 15, 2021 REISSUED FOR PERMIT





PROJECT # 21-09-100 WADDELL ENGINEERING LTD. 119 PINEBUSH RD. CAMBR. PH. 519-267-6789 FAX. 1-866-388-9659 INFO@WADDELLENG.COM

* CERTIFICATION OF STRUCTURAL ITEMS NOTED




JOHN & WENDY GIBSON

1611 SQ' FT. COTTAGE

1090 BOYCE ROAD PORT CARLING, ON P0B 1J0

FOUNDATION PLAN

As Note M. FREY

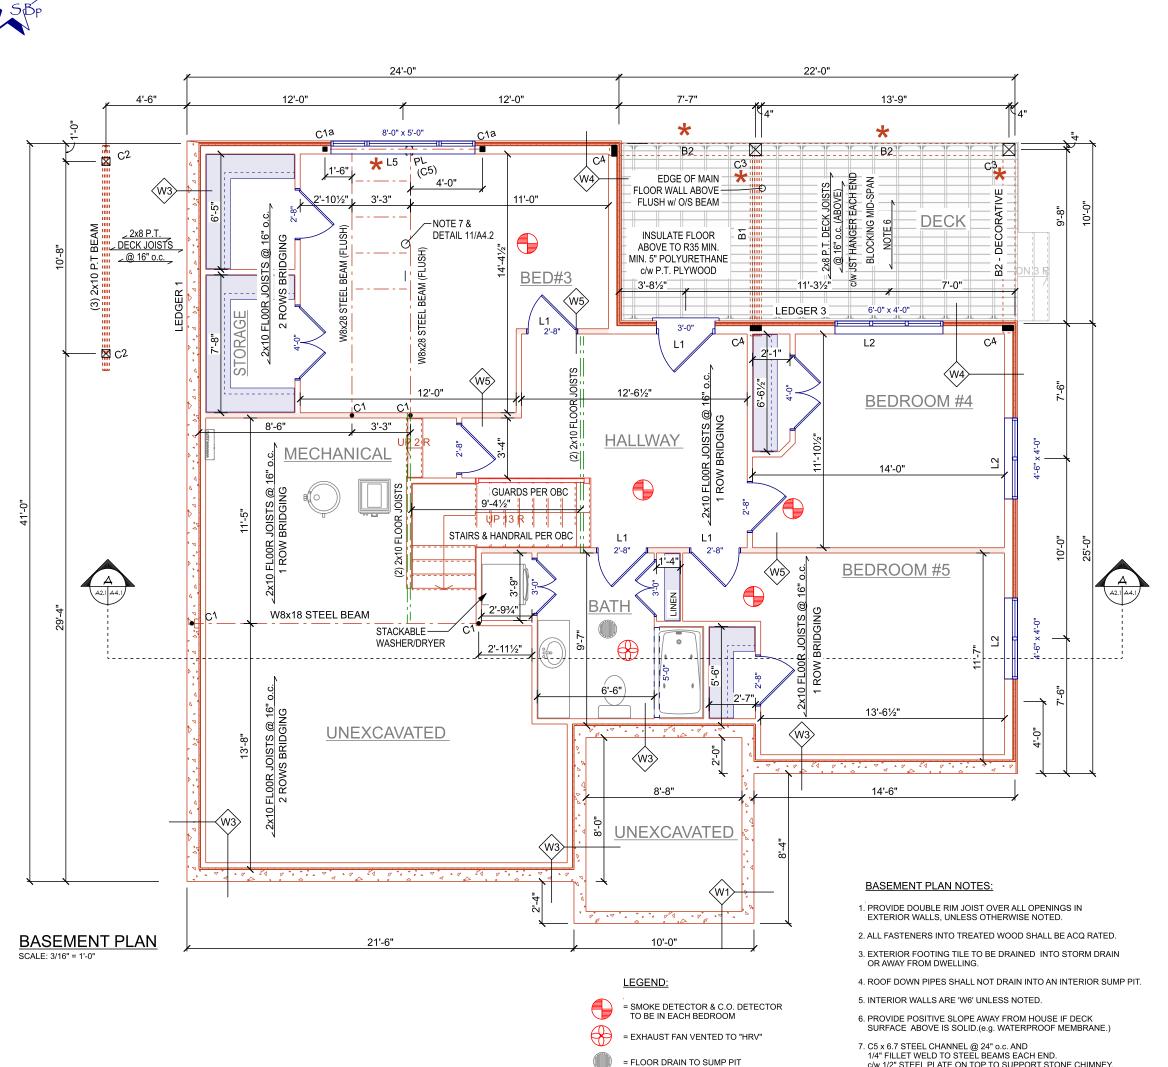

ASPHALT DAMPPROOFING PLASTIC DRAINAGE BOARD

8" BASEMENT WALL:
½" DRYWALL TAPED & SANDED
S6 mil POLY VAPOR BARRIER 2 x 4 STUDS @ 16" o.c. R14 BATT INSULATION 1" RIGID INSULATION

TYPAR HOUSEWRAP 8" CONCRETE FOUNDATION WALL ASPHALT DAMPPROOFING PLASTIC DRAINAGE BOARD

2x6 SIDING EXTERIOR WALL:
WOOD SHIPLAP HALF-LOG SIDING
3/4" VERTICAL STRAPPING @ 16" o.c. 1" RIGID INSULATION (JOINTS TAPED) 7/16" OSB SHEATHING

2x6 STUDS @ 16" o.c. R22 BATT INSULATION S6 MIL POLY VAPOR BARRIER 1/2" DRYWALL TAPED & SANDED

INTERIOR FRAME WALL ASSEMBLIES

W5 2x4 BEARING PARTITION WALL:
1/2" DRYWALL TAPED & SANDED 2x4 STUDS @ 16" o.c. ½" DRYWALL TAPED & SANDED THICKENED FLOOR FOOTING

W6 2x4 PARTITION WALL:
1/2" DRYWALL TAPED & SANDED 2x4 STUDS @ 16" o.c. ½" DRYWALL TAPED & SANDED

LINTEL/BEAM SCHEDULE:

- (2) 2x6 HEADER c/w
- (1) 2x4 STUD BEARING & 1 KING EACH END
- (2) 2x10 HEADER c/w

L1 =

(1) 2x4 STUD BEARING & 1 KING EACH END

***** L5 = W8x21 STEEL BEAM WINDOW LINTEL BEARING ON COLUMNS AS NOTED.
(JACK POSTS TO MIN. 15,000 lbs WORKING LOAD RATINGO T/O BEAM 1.5" DOWN FROM T/O WALL TO PROVIDE FOR 2x6 NAILING PLATE WOOD PLATE REPLACED WITH STEEL SHIMS AT SUPPORTED BEAMS. SEE DETAIL 11/A4.2

> (5) 2x10 BUILT UP BEAM (FLUSH IN FLOOR SYSTEM) BEARING ON COLUMNS NOTED. PROVIDE SECURE CONTINUOUS CONNECTION TO COLUMN 'C3' BELOW

8x10 No. 2 or BTR PINE BEAM SIMPSON CBT2Z BRACKET TO COLUMN

COLUMN SCHEDULE

C1 = 3" STEEL JACK POST c/w 10" x 10" x 1/2" STEEL BASEPLATE
AND FASTENED TO BEAM AT TOP PER MFG. (MIN. 10,000 lbs. WORKING LOAD RATING) DETAIL 3/A4.2

C1a = 3" x 3" x 1/4" HSS STEEL POST c/w 10" x 10" x 1/2" STEEL BASEPLATE (MIN. 15,000 lbs. WORKING LOAD RATING)

C2 = 6x6 P.T. No. 2 OR BTR POST c/w SIMPSON CBT2Z BRACKET AT TOP & SADDLE BRACKET ANCHORED TO PIER

8x8 No. 2 OR BTR PINE POST c/w SADDLE BRACKET ANCHORED TO PIER

> (5) 2x4 STUD POST IN WALL **SÉT UNDER BEAM**

c/w 1/2" STEEL PLATE ON TOP TO SUPPORT STONE CHIMNEY.

LEDGER SCHEDULE:

LDGR1 = 2x8 LEDGER SCREWED TO RIM JOIST c/w 5" LEDGER SCREWS (OR EQUIVALENT) SCREWS @ 12" o.c. (STAGGERED) SEE DETAIL 7/A4.2

2x8 LEDGER SCREWED TO RIM JOIST c/w 5" LEDGERLOK SCREWS (OR EQUIVALENT) SCREWS @ 5" o.c. (STAGGERED) SEE DETAIL 7/A4.2



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BCIN 28073

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REVISION SCHEDULE REVISION NOTE OCT 6, 2020 FDN PLAN REVISION PER SITE CONDITION

OCT 9, 2020 FDN REVISION-WALL OFFSET BELOW DECK NOV 09, 2020 CHANGE MAIN ROOF TO GABLED ENDS

OCT 11, 2021 REMOVE EXISTING STONE FDN WALI NOV 15, 2021 REISSUED FOR PERMIT

PROJECT # 21-09-100 WADDELL

ENGINEERING LTD. 119 PINEBUSH RD. CAMBR PH. 519-267-6789 FAX. 1-866-388-9659 INFO@WADDELLENG.COM

* CERTIFICATION OF STRUCTURAL ITEMS NOTED



JOHN & WENDY GIBSON

1611 SQ' FT. COTTAGE

1090 BOYCE ROAD PORT CARLING, ON P0B 1J0


BASEMENT PLAN

As Note

M. FREY


A2.2


FOR INFORMATIONAL PURPOSES <u>FLOOR PLANS - SECOND STOREY</u> <u>NOT TO SCALE</u>

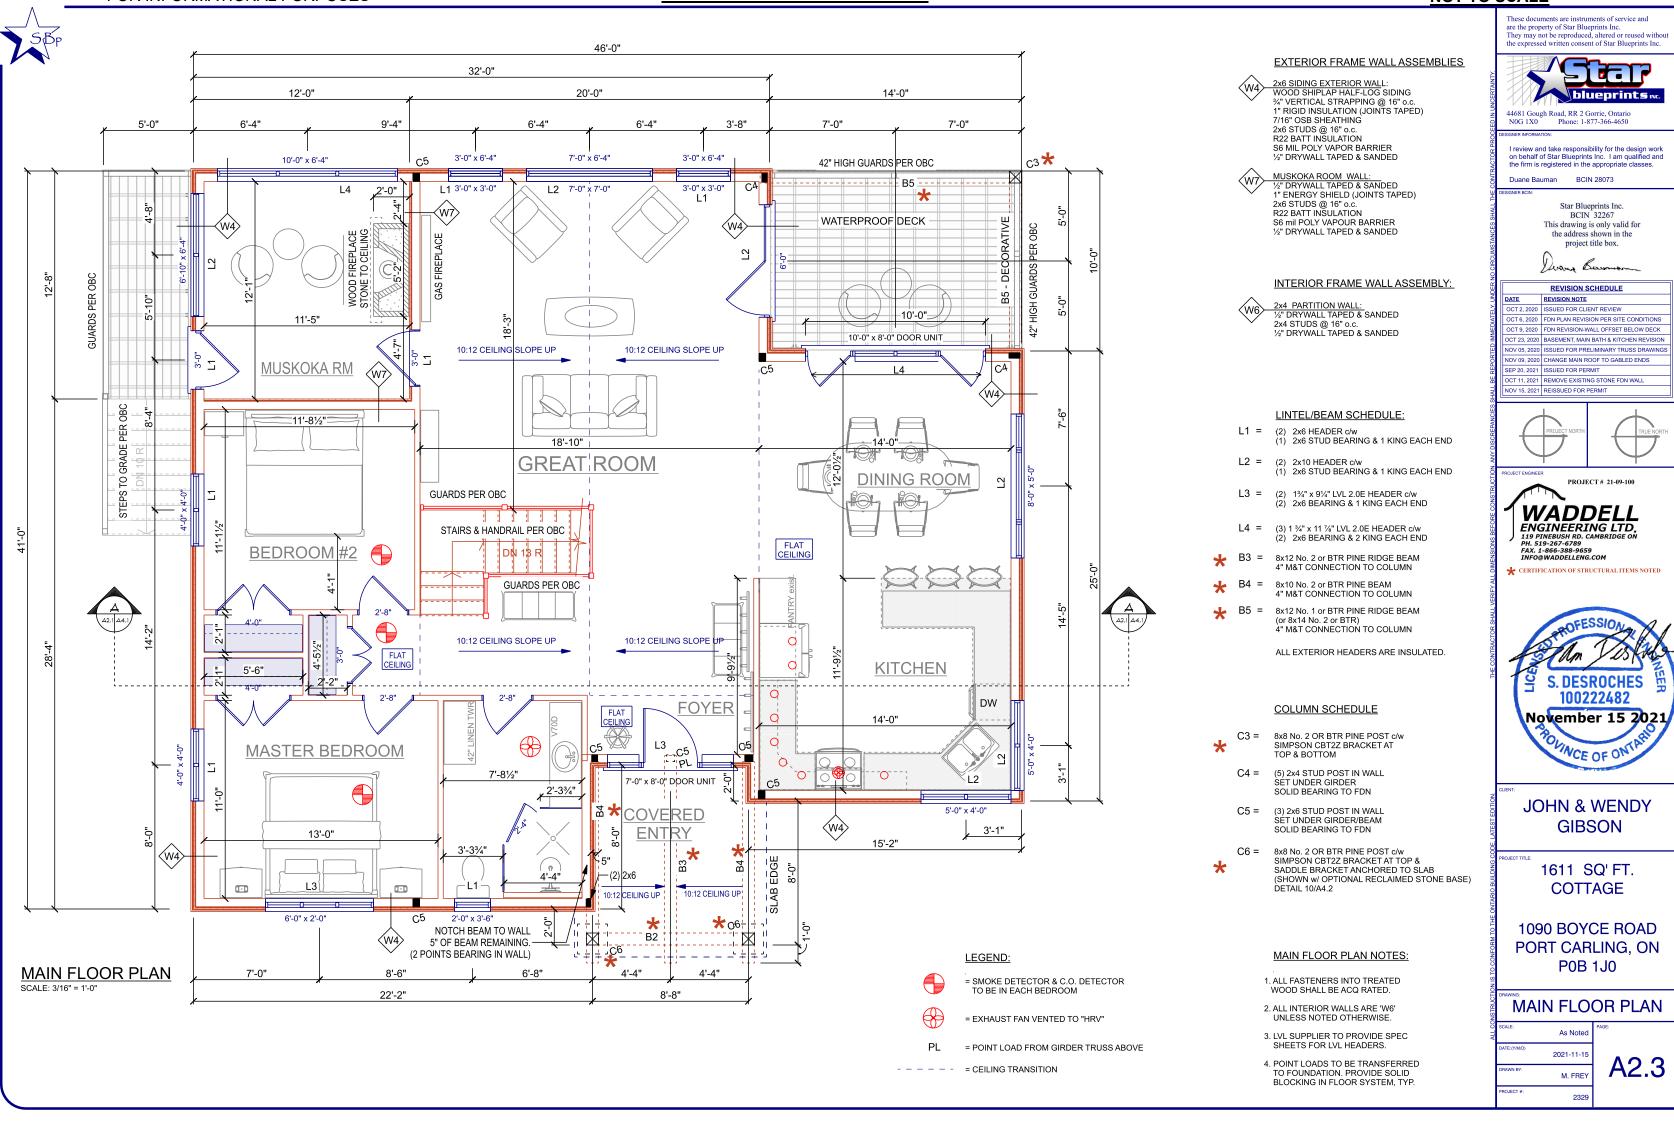

FOR INFORMATIONAL PURPOSES <u>ELEVATION DRAWINGS</u> <u>NOT TO SCALE</u>



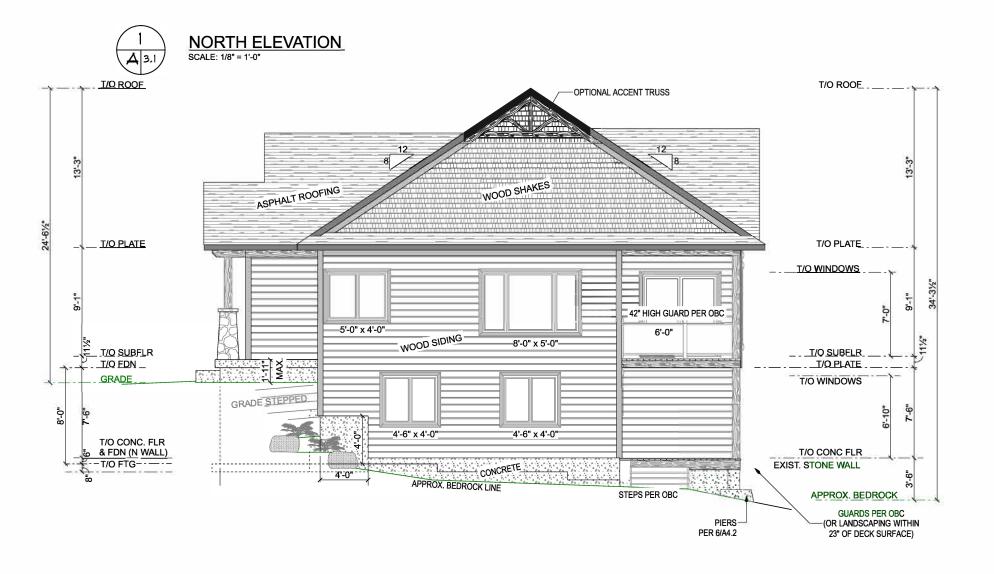

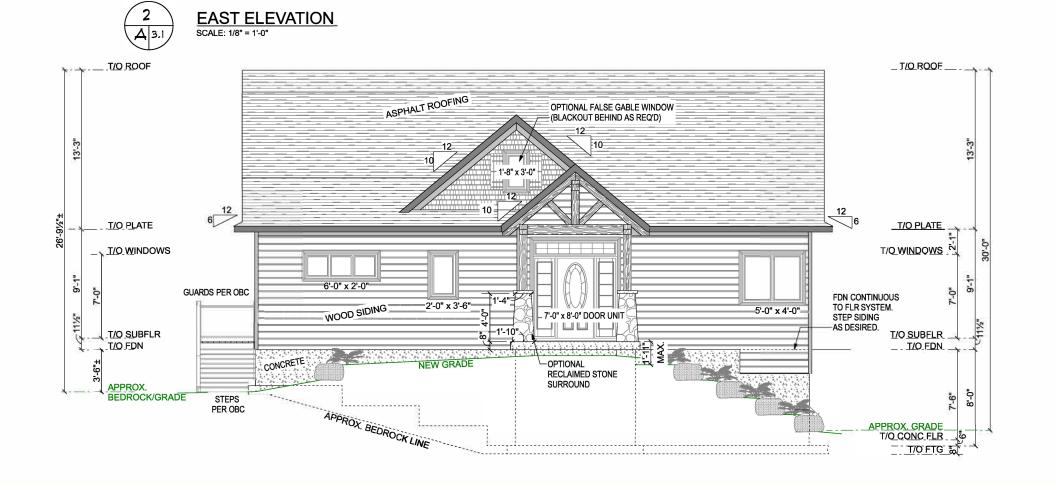

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NOG 1X0 Phone: 1-877-366-4650

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Duano Duaman

Star Blueprints Inc.
BCIN 32267
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Duany Barman

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JOHN & WENDY GIBSON

PROJECT TITL

1611 SQ' FT. COTTAGE

1090 BOYCE ROAD PORT CARLING, ON POB 1J0


N & E ELEVATIONS




A3.1

FOR INFORMATIONAL PURPOSES <u>ELEVATION DRAWINGS</u> <u>NOT TO SCALE</u>



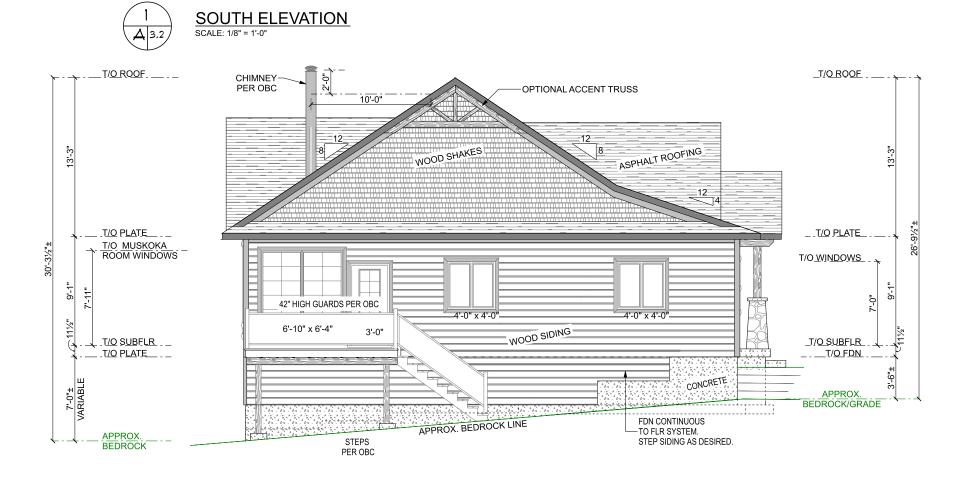

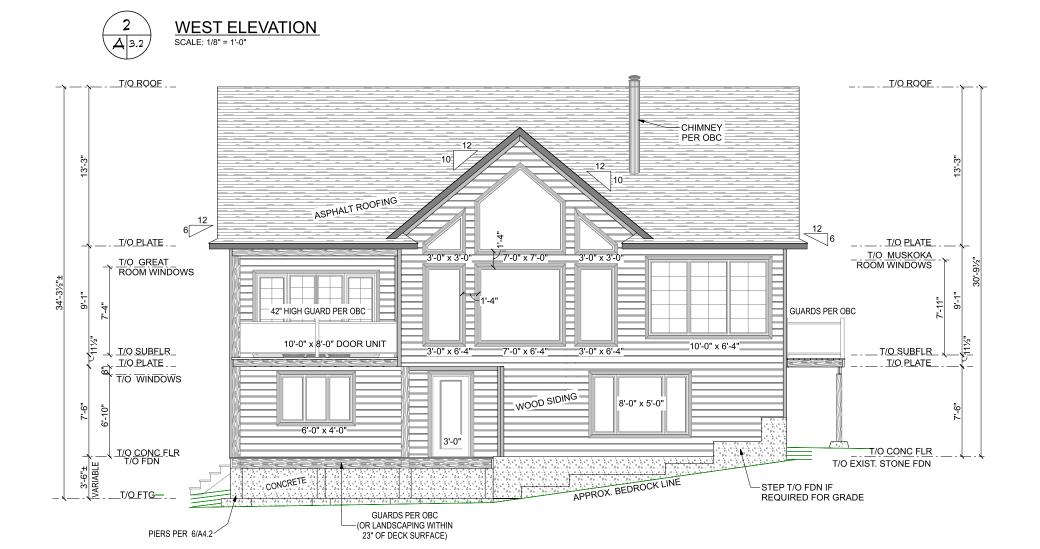

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Duane Bauman BCIN 28073

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JOHN & WENDY GIBSON

PROJECT TITLE:

1611 SQ'FT. COTTAGE

1090 BOYCE ROAD PORT CARLING, ON P0B 1J0

S & W ELEVATIONS

1/8" = 1'-0"

DATE:(Y/MD) 2021-11-15

DRAWN BY: M. FREY

A3.2

