

THE CORPORATION OF THE TOWNSHIP OF MUSKOKA LAKES

COMMITTEE OF ADJUSTMENT

NOTICE OF PUBLIC HEARING OF APPLICATION FOR MINOR VARIANCE

This notice has been sent to you for your information and does not require any response unless you wish to make one.

TAKE NOTICE THAT the Committee of Adjustment for The Corporation of the Township of Muskoka Lakes will be considering the following proposed minor variance to Zoning By-Law 2014-14 pursuant to Section 45 of the Planning Act, R.S.O. 1990, c. P.13.

Hearing Date: Monday, March 11th, 2024 at 9:00 a.m.

File #.: A-11/24 Roll #: 6-18-018 Civic Address: 1024 Sunset Bay Road Owner: Linda Woolsey, 6 Fry Court, Markham, L3P 4G9 Legal Description: Lot 16, Concession D, Lot 26, Plan M-436, (Medora) Lake/River: Lake Muskoka (Category 1 Lake) Zoning: Waterfront Residential (WR1) Zoning Schedule: 41

EXPLANATION OF THE PURPOSE AND EFFECT: The applicant proposes to demolish an existing two storey dwelling and a boatport and proposes to construct a new two storey dwelling.

Variance	ZBL 2014-14 Section(s)	Description	Permitted	Proposed	Variance
A	4.1.3.6 & 4.1.3.7	Maximum Lot Coverage Within 200 Feet	10% (2,092.5 sq. ft.)	10.9% (2,289 sq. ft.)	196.5 sq. ft.

A key map of the subject property and the applicants' site plan and any drawings are included in this notice.

TAKE FURTHER NOTICE that this public hearing will be held in a hybrid forum with electronic ZOOM participation, and in-person format for those wishing to attend in person. The meeting will be held in the **Council Chambers, Municipal Office, 1 Bailey Street, Port Carling, Ontario, and will commence at 9:00 a.m.**


ZOOM Guide

More information about viewing and/or participating in the zoom hearing can be found on our website: https://www.muskokalakes.ca/zoom/

Electronic Version of Notice of Hearing

Should you wish to view an electronic copy of the Notice of Hearing for the above-noted application, please visit

https://www.muskokalakes.ca/planning-notices/ or scan the QR code:

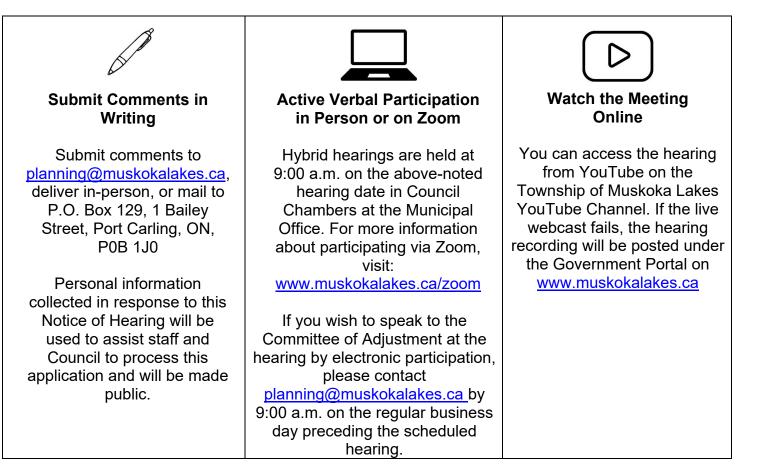

For more information, please contact the Planning Department weekdays between 8:15 a.m. and 4 p.m. at the Municipal Office, or at planning@muskokalakes.ca or by phone at (705) 765-3156. Please quote the file number noted above.

FAILURE TO PARTICIPATE: If you do not participate in the hearing it may proceed in your absence and, except as otherwise provided in the Planning Act, you will not be entitled to any further notice in the proceedings.

DECISION & APPEALS: If you wish to be notified of the decision of the Committee of Adjustment in respect to this application, you must make a written request to planning@muskokalakes.ca. Furthermore, no one other than the applicant, the municipality, certain public bodies and the minister may file an appeal of the decision of the Committee of Adjustment in respect of the proposed variance. If they do not make written submission to the Secretary Treasurer before the variance is approved or refused. then the Ontario Land Tribunal may dismiss the appeal.




PLEASE NOTE: THE COMMITTEE OF ADJUSTMENT IS A JUDICIAL BODY WHICH MAKES DECISIONS SOLELY ON INFORMATION GATHERED AS A COMMITTEE. COMMITTEE MEMBERS ARE NOT TO BE CONTACTED PRIOR TO THE HEARING DATE TO AVOID A CONFLICT OF INTEREST.


Dated this 29th day of February, 2024.

<u>"Original Signed by C. Ward"</u> Chelsea Ward, Secretary-Treasurer Committee of Adjustment

KEY MAP

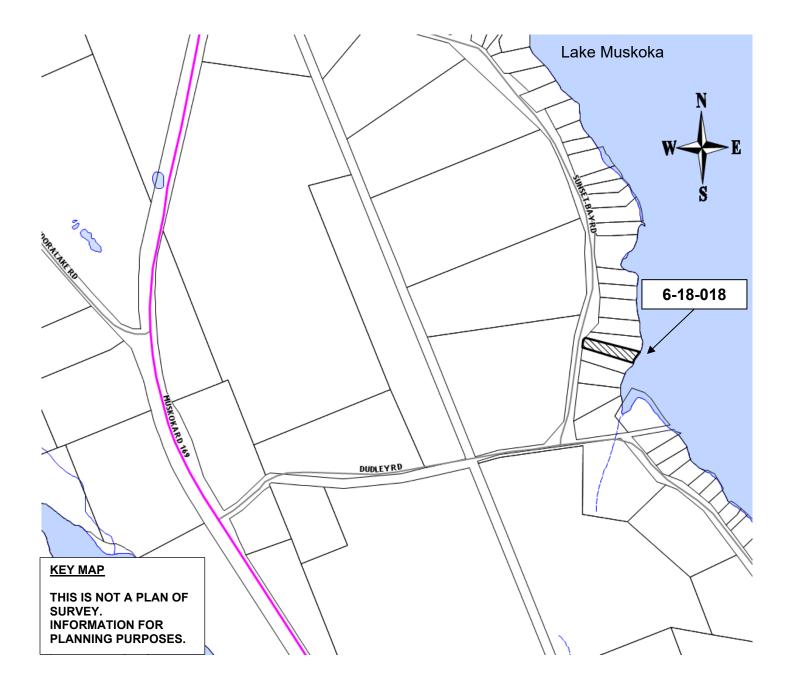



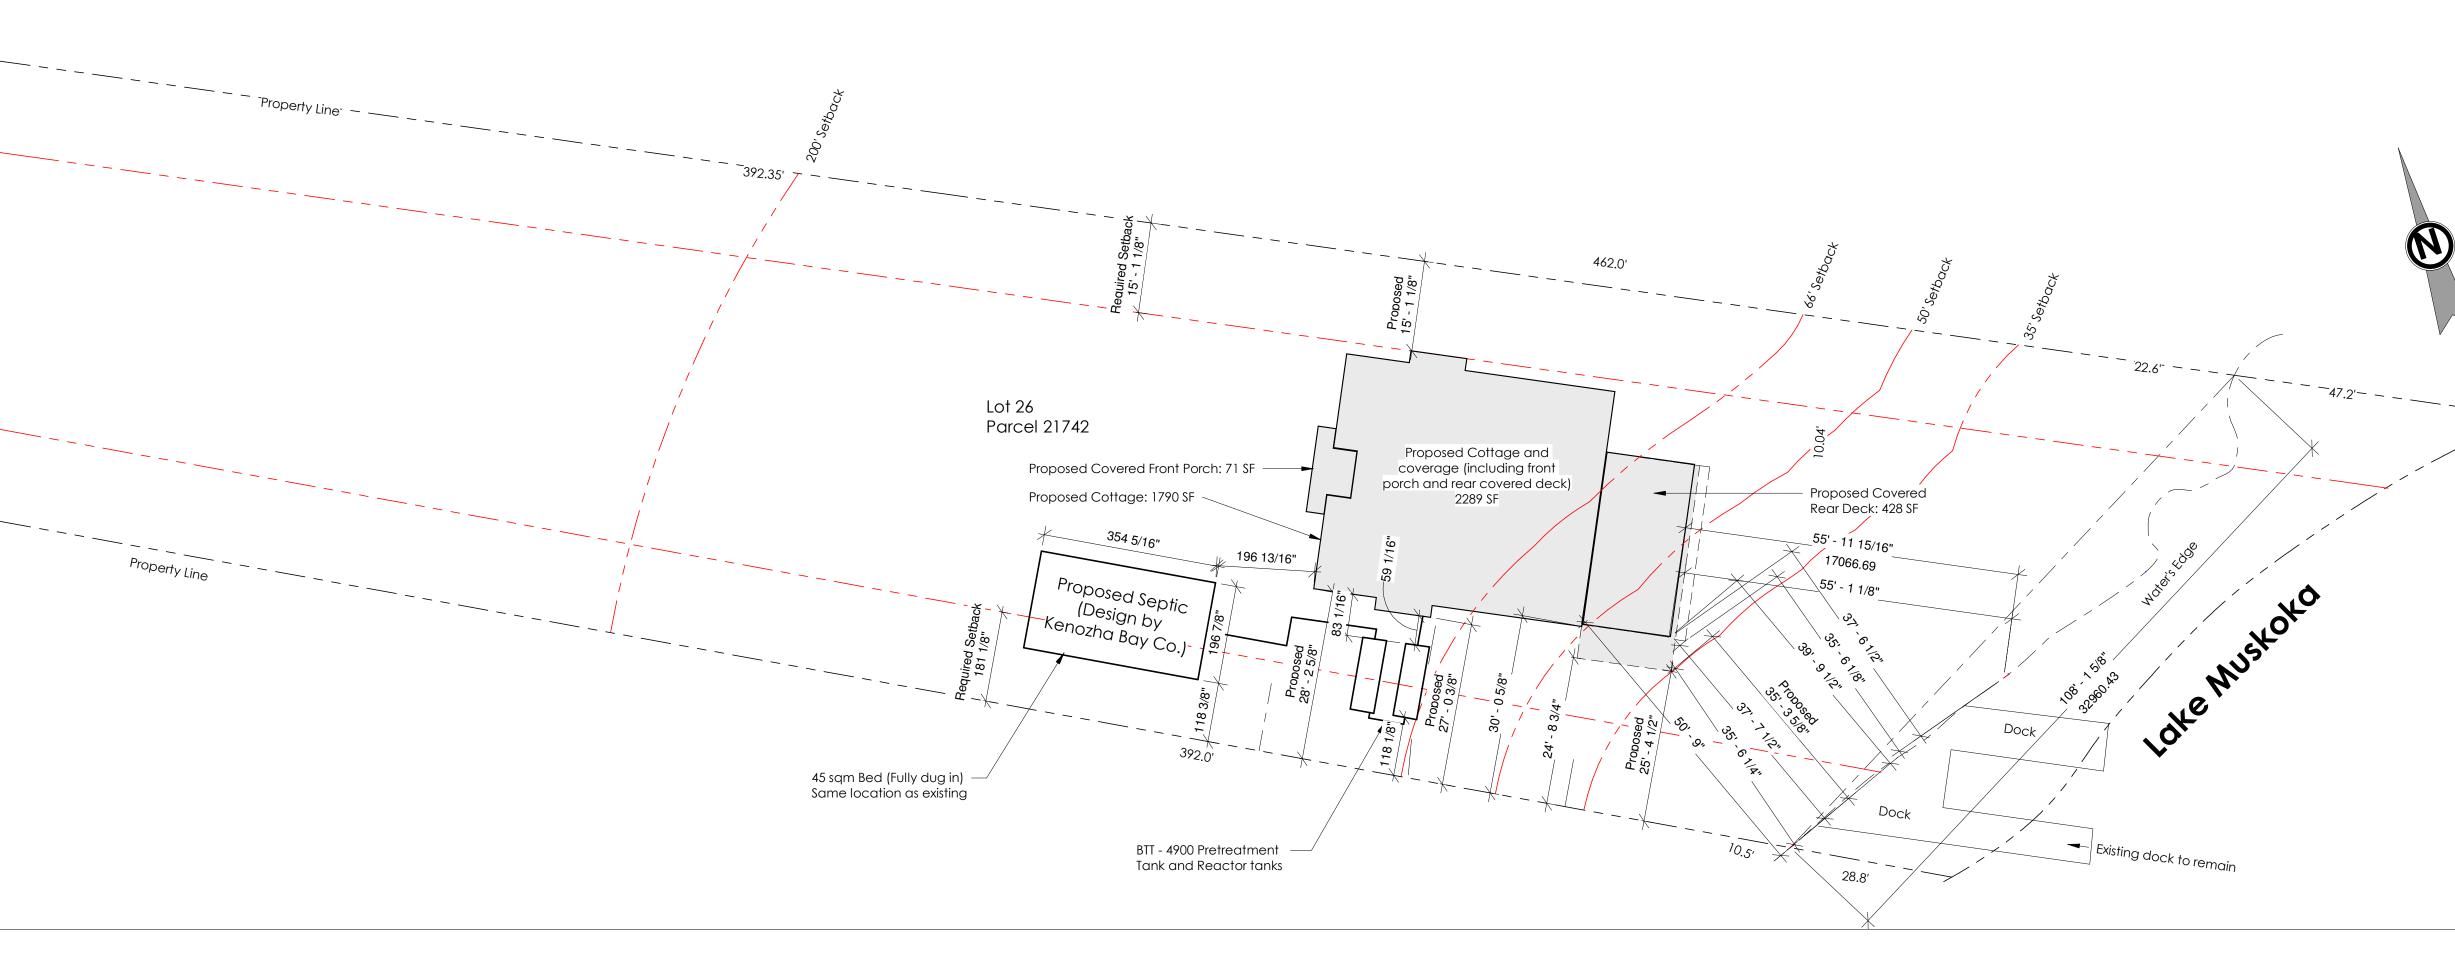


Existing Site Plan

FOR INFORMATIONAL PURPOSES ONLY

REQUIREMENTS						
		W	R1			
		Lake Muskoka				
		Category 1				
	%	SQFT	SQM			
	10%	3295.5	306.16			
	10%	2092.5	194.35			
		FEET	METERS			
		108	32.92			
		66	20			
		15	5			
		30	10			
		10	3			
		15	5			
		35	10.6			

EXISTING LOT COVERAGE CALCULATIONS					
	%	SQFT.	SQM.		
Area of Total Lot	Area of Total Lot				
Area of Lot Within 200 FT/60M.		20,925	1944		
Area of Existing Cottage (Demolish)		1712.01	159.05		
Area of Existing Boatport (Den	Area of Existing Boatport (Demolish)		26.54		
Area of Existing Covered Deck	Area of Existing Covered Deck (Demolish)		55.74		
Area of Proposed Cottage	Area of Proposed Cottage		166.2		
Area of Proposed Front Porch		71	6.5		
Area of Proposed Covered De	eck	428	28.05		
Totals:					
Existing Lot Coverage (Within 200ft)			12.4%		
Existing Lot Coverage (Total)			7.88%		
Proposed Lot Coverage (Within 200ft)			10.94		
Proposed Lot Coverage (Total)		6.94%		

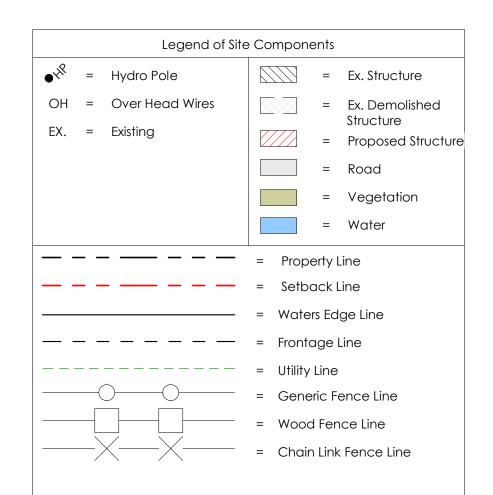






No.	Description Revised For Permit	Date October 2, 202
Addre: 102	ss 24 Sunset Bay Rd, Tow Lakes	nship of Muskok
	24 Sunset Bay Rd, Tow Lakes	-
102 Client Design The th requ	24 Sunset Bay Rd, Tow Lakes Name Woolsey Cot	tage takes responsibility for ations and meets the b Building Code to be a ORMATION t under 2.17.5.1 of the
102 Client Design The th requ Re	24 Sunset Bay Rd, Tow Lakes Name Woolsey Cot ner undersigned has reviewed and is design, and has the qualific uirements set out in the Ontario designer. QUALIFICATIONS INF quired unless design is exemp building code	tage d takes responsibility for ations and meets the b Building Code to be a ORMATION t under 2.17.5.1 of the b.
102 Client Design The th requ Re NM	24 Sunset Bay Rd, Tow Lakes Name Woolsey Cot ner undersigned has reviewed and is design, and has the qualific uirements set out in the Ontario designer. QUALIFICATIONS INF quired unless design is exemp building cod	tage takes responsibility for ations and meets the b Building Code to be a ORMATION t under 2.17.5.1 of the
102 Client Design The th requ Re NM NAME Re Spenc FIRM	24 Sunset Bay Rd, Tow Lakes Name Woolsey Cot ner undersigned has reviewed and is design, and has the qualific uirements set out in the Ontario designer. QUALIFICATIONS INF quired unless design is exemp building cod SIGNATU REGISTRATION INFC quired unless design is exemp	tage takes responsibility for ations and meets the b Building Code to be a ORMATION t under 2.17.5.1 of the
102 Client Design The th requ Re NM NAME Re Spenc FIRM Sheet	24 Sunset Bay Rd, Tow Lakes Name Woolsey Cot ner undersigned has reviewed and is design, and has the qualific uirements set out in the Ontario designer. QUALIFICATIONS INF quired unless design is exemp building cod SIGNATU REGISTRATION INFC quired unless design is exemp 	tage takes responsibility for ations and meets the b Building Code to be a ORMATION t under 2.17.5.1 of the

NOT TO SCALE

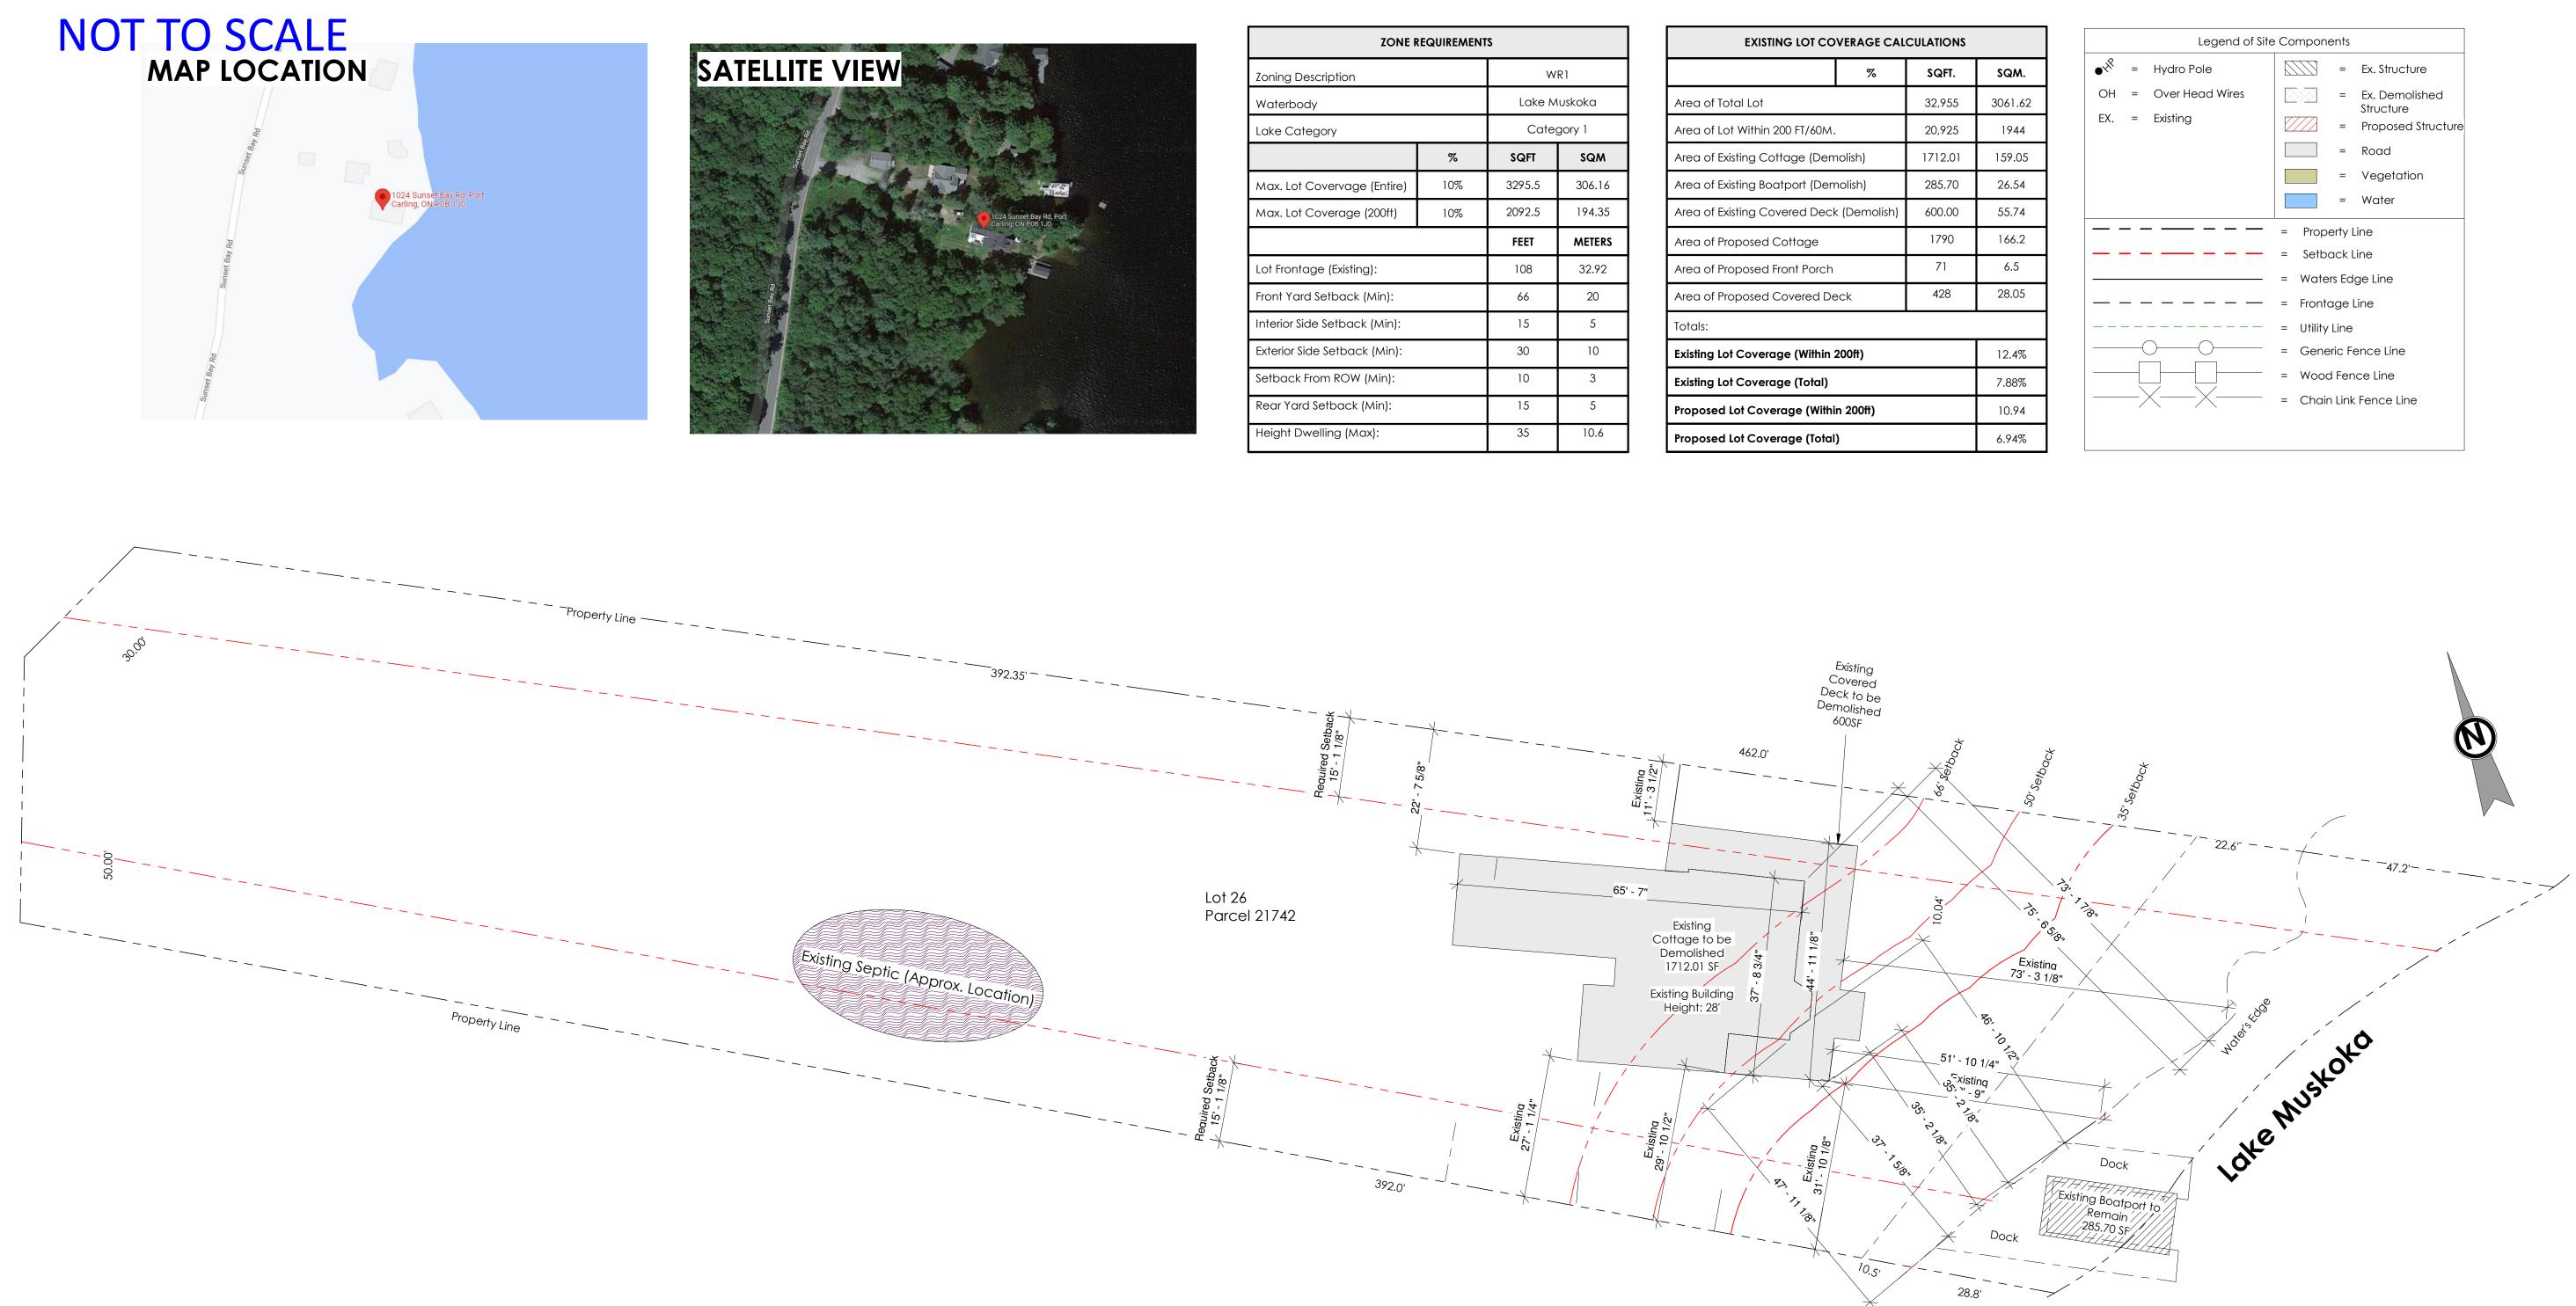

1 <u>D_Site Plan</u> 1/16" = 1'-0"

Proposed Site Plan

FOR INFORMATIONAL PURPOSES ONLY

ZONE REQUIREMENTS				
Zoning Description		W	R1	
Waterbody		Lake M	luskoka	
Lake Category		Category 1		
	%	SQFT	SQM	
Max. Lot Covervage (Entire)	10%	3295.5	306.16	
Max. Lot Coverage (200ft)	10%	2092.5	194.35	
		FEET	METERS	
Lot Frontage (Existing):		108	32.92	
Front Yard Setback (Min):		66	20	
Interior Side Setback (Min):		15	5	
Exterior Side Setback (Min):		30	10	
Setback From ROW (Min):		10	3	
Rear Yard Setback (Min):		15	5	
Height Dwelling (Max):		35	10.6	


EXISTING LOT COVERAGE CALCULATIONS					
	%	SQFT.	SQM.		
Area of Total Lot		32,955	3061.62		
Area of Lot Within 200 FT/60M.		20,925	1944		
Area of Existing Cottage (Demolish)		1712.01	159.05		
Area of Existing Boatport (Den	nolish)	285.70	26.54		
Area of Existing Covered Decl	Area of Existing Covered Deck (Demolish)		55.74		
Area of Proposed Cottage		1790	166.2		
Area of Proposed Front Porch		71	6.5		
Area of Proposed Covered De	eck	428	28.05		
Totals:					
Existing Lot Coverage (Within :	200ft)		12.4%		
Existing Lot Coverage (Total)			7.88%		
Proposed Lot Coverage (Within 200ft)			10.94		
Proposed Lot Coverage (Total)		6.94%		



Jre
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Structure
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Soo			
		cer las	
PLANNING			
No. Description 2 Issued For Demolition		Date February 13, 20)23
Address			
1024 Sunset Bay Rd	, Townsh akes	ip of Muskoka	a
Client Name			
	y Cottage	e	
Designer The undersigned has review this design, and has the o			or
requirements set out in the	Ontario Bui signer. NS INFORM	Iding Code to be a	l
	ng code.		
L NM		437	'47
NAME SIC REGISTRATIO Required unless design is		BC ATION	
Spencer Douglas LTD FIRM NAME		1174 FIRM BC	413 CIN
Sheet Name Demolitio	n Sit	e Plan	
Project Number Date	1/23/20	22-060 024 4:50:02 P	'N
Drawn By Checked By		Auth Check	
D- Scale	100	As indicate	<u>ə</u> r
		no multate	JU



PURPOSES, FOR STRUCTURAL REINFORCEMENT REFER TO S-SERIES DRAWINGS.

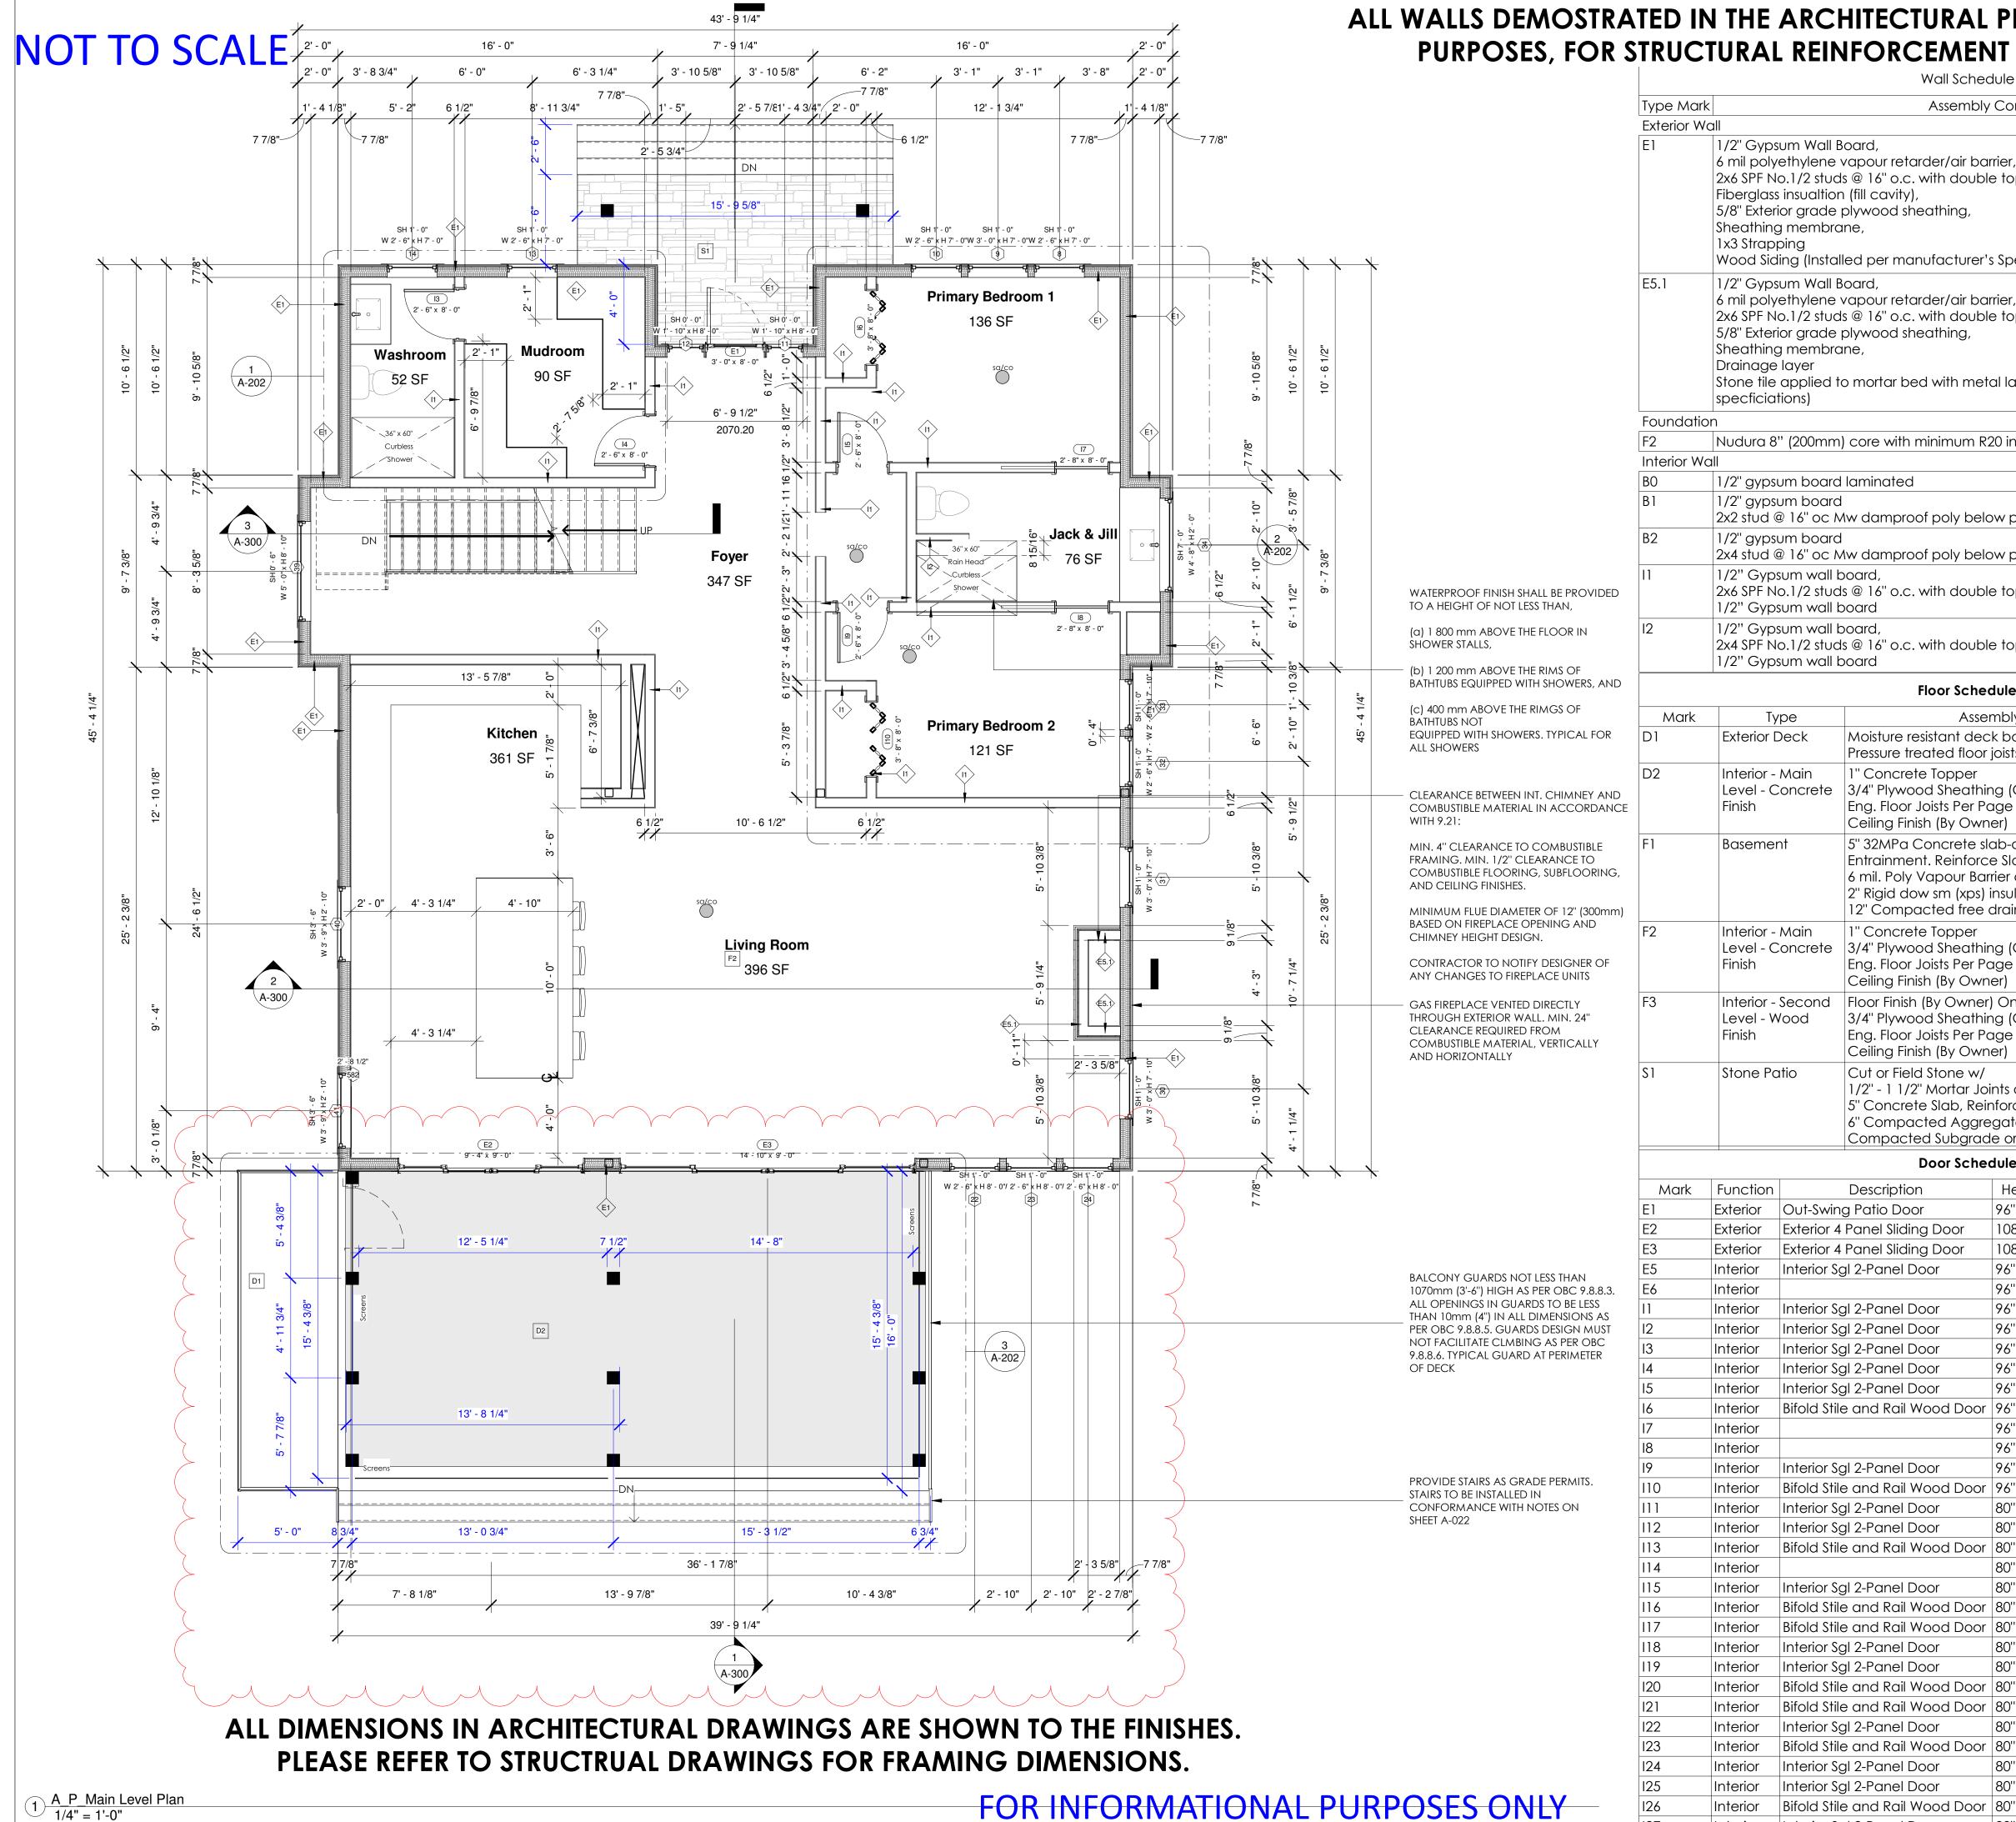Wood Siding (Installed per manufacturer's Specifications) 1/2" Gypsum Wall Board, 6 mil polyethylene vapour retarder/air barrier, 2x6 SPF No.1/2 studs @ 16" o.c. with double top plate, 5/8" Exterior grade plywood sheathing, Sheathing membrane, Drainage layer Stone tile applied to mortar bed with metal lathe (installed as per manufacturer's specficiations) Nudura 8" (200mm) core with minimum R20 insulation, c/w taper top course 1/2" gypsum board laminated 1/2" gypsum board 2x2 stud @ 16" oc Mw damproof poly 1/2" gypsum board 2x4 stud @ 16" oc Mw damproof poly 1/2" Gypsum wall board, 2x6 SPF No.1/2 studs @ 16" o.c. with de 1/2" Gypsum wall board 1/2" Gypsum wall board, 2x4 SPF No.1/2 studs @ 16" o.c. with de 1/2" Gypsum wall board Floor 3 Type Exterior Deck Moisture resistant Pressure treated 1" Concrete Topp Interior - Main 3/4" Plywood She Level - Concrete Eng. Floor Joists F Ceiling Finish (By 5" 32MPa Concre Basement Entrainment. Rei 6 mil. Poly Vapou 2" Rigid dow sm 12" Compacted 1" Concrete Top Interior - Main Level - Concrete 3/4" Plywood She Eng. Floor Joists | Ceiling Finish (By Interior - Second Floor Finish (By O 3/4" Plywood She Level - Wood Eng. Floor Joists | Ceiling Finish (By Cut or Field Ston Stone Patio 1/2" - 1 1/2" Mort 5" Concrete Slab 6" Compacted A Compacted Subgrade or Undisturbed Soil **Door Schedule** Description Exterior Out-Swing Patio Door Exterior Exterior 4 Panel Sliding Door Exterior Exterior 4 Panel Sliding Door Interior Sgl 2-Panel Door Bifold Stile and Rail Wood Do Interior Sgl 2-Panel Door Bifold Stile and Rail Wood Do Interior Sgl 2-Panel Door Interior Sgl 2-Panel Door Bifold Stile and Rail Wood Do Interior Sgl 2-Panel Door Bifold Stile and Rail Wood Do

127

Interior

ALL WALLS DEMOSTRATED IN THE ARCHITECTURAL PLANS ARE SHOWN FOR ILLUSTRATIVE

Wall Schedule Assembly Components

2x6 SPF No.1/2 studs @ 16" o.c. with double top plate,

y below plate	
y below plate	
double top plate,	
double top plate,	
Schedule	
Assembly Components	Area
t deck boards floor joists as per Structural plan	80 SF
per eathing (Glued and Nailed) On Per Page S-100-103 ' Owner)	474 SF
ete slab-on-grade c/w 5-8% Air nforce Slab with 6" wire mesh on ur Barrier on (xps) insulation on free draining granular fill.	1671 SF
per eathing (Glued and Nailed) On Per Page S-100-103 ' Owner)	1743 SF
owner) On eathing (Glued and Nailed) On Per Page S-100-103 o Owner)	1846 SF
ie w/ tar Joints on b, Reinforce if Required on Aggregate on	103 SF

n	Description	Height	Width	Level
	Out-Swing Patio Door	96"	36''	Proposed Main Level
	Exterior 4 Panel Sliding Door	108"	112"	Proposed Main Level
	Exterior 4 Panel Sliding Door	108"	178''	Proposed Main Level
	Interior Sgl 2-Panel Door	96"	32"	T/O Proposed Slab
		96"	30''	T/O Proposed Slab
	Interior Sgl 2-Panel Door	96''	36''	T/O Proposed Slab
	Interior Sgl 2-Panel Door	96"	36"	T/O Proposed Slab
	Interior Sgl 2-Panel Door	96''	30''	Proposed Main Level
	Interior Sgl 2-Panel Door	96"	30''	Proposed Main Level
	Interior Sgl 2-Panel Door	96"	30''	Proposed Main Level
	Bifold Stile and Rail Wood Door	96''	44''	Proposed Main Level
		96''	32''	Proposed Main Level
		96''	32''	Proposed Main Level
	Interior Sgl 2-Panel Door	96''	30''	Proposed Main Level
	Bifold Stile and Rail Wood Door	96''	44''	Proposed Main Level
	Interior Sgl 2-Panel Door	80''	30''	Proposed Second Level
	Interior Sgl 2-Panel Door	80''	30''	Proposed Second Level
	Bifold Stile and Rail Wood Door	80''	44''	Proposed Second Level
		80''	32''	Proposed Second Level
	Interior Sgl 2-Panel Door	80''	30''	Proposed Second Level
	Bifold Stile and Rail Wood Door	80''	44''	Proposed Second Level
	Bifold Stile and Rail Wood Door	80''	44''	Proposed Second Level
	Interior Sgl 2-Panel Door	80''	30''	Proposed Second Level
	Interior Sgl 2-Panel Door	80''	30''	Proposed Second Level
	Bifold Stile and Rail Wood Door	80''	44''	Proposed Second Level
	Bifold Stile and Rail Wood Door	80''	44''	Proposed Second Level
	Interior Sgl 2-Panel Door	80''	30''	Proposed Second Level
	Bifold Stile and Rail Wood Door	80''	44''	Proposed Second Level
	Interior Sgl 2-Panel Door	80''	30''	Proposed Second Level
	Interior Sgl 2-Panel Door	80''	30''	Proposed Second Level
	Bifold Stile and Rail Wood Door	80''	44''	Proposed Second Level
	Interior Sgl 2-Panel Door	80''	30''	Proposed Second Level

. L /			12 1
No. 1 5	Descri Descri Issued For Permit For Township Pre	ption	Date March 29, 2023 Date 5
	DER		- #•
	PER	MIT	- #:
Addres			
			#:
102	s 4 Sunset Bay Name	Rd, Townsl	hip of Muskoka
102 Client I Design The u thi requ	s 4 Sunset Bay Name Woo er undersigned has re s design, and has f irements set out in QUALIFICAT quired unless desig	Rd, Townsl Lakes Isey Cottag	hip of Muskoka
102 Client I Design The u thi requ	s 4 Sunset Bay Name Woo er undersigned has re s design, and has f irements set out in QUALIFICAT quired unless desig	Rd, Townsl Rd, Townsl Lakes Isey Cottag	hip of Muskoka
102 Client I Design The t thi requ Rec	s 4 Sunset Bay Vame Woo er undersigned has re s design, and has te irements set out in QUALIFICA juired unless desig bu REGISTRA quired unless desig	Rd, Townsk Lakes Isey Cottag viewed and tak the qualification the Ontario Bu designer. FIONS INFORI n is exempt un ailding code. SIGNATURE TION INFORI	hip of Muskoka le kes responsibility for hs and meets the hilding Code to be a MATION der 2.17.5.1 of the der 2.17.5.1 of the

Checked By

Scale

A-102

1/4" = 1'-0"

NOT TO SCALE



2 P_Rear Elevation 1/4" = 1'-0"

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Sp	e		Cer
Dc		\cap	las
No.	Description		Date
4 Revised F	For Permit ship Precons	ultation	March 29, 2023 October 2, 2023 Date 5
PERMIT #:			
Address			
		Towns kes	hip of Muskoka
Client Name	Woolsey	/ Cottac	1e
Designer			, -
The undersigned has reviewed and takes responsibility for this design, and has the qualifications and meets the requirements set out in the Ontario Building Code to be a designer.			
QUALIFICATIONS INFORMATION Required unless design is exempt under 2.17.5.1 of the building code.			
	N.		43743
NAME SIGNATURE BCIN REGISTRATION INFORMATION Required unless design is exempt under 2.17.4.1 of the building code.			
Spencer Douglas FIRM NAME		y JUUE.	<u>117413</u> FIRM BCIN
Sheet Name Elevations			
		αιιΟΙ	
Project Number Date Drawn By		1/25/2	22-0601 2024 3:40:23 PM NM
Checked By	~ ~		NM
A-200			

1/4" = 1'-0"

Scale