

DARK BAY ROAD BRIDGE REPLACEMENT


TOWNSHIP OF MUSKOKA LAKES, ON



LIST OF DRAWINGS

C0	COVER
C1	REMOVALS PLAN & PROFILE
C2	NEW CONSTRUCTION PLAN & PROFILE
D1	DETAILS

THE GREER GALLOWAY GROUP INC.
CONSULTING ENGINEERS

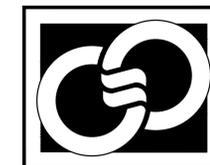

PETERBOROUGH
BELLEVILLE
KINGSTON

640 CATARAQUI WOODS DRIVE, UNIT 2A
KINGSTON, ONTARIO K7P 2Y5
PHONE: (613) 536-5420

CAD OPERATOR: Shigh
 CAD FILE: X:\Kingston Archives\5000 - Municipal\2023\2355361 - Dark Bay Road Bridge Replacement\Drawings\Working Drawings\Dark Bay Bridge Replacement - IT.dwg
 PLOT SCALE: AS NOTED
 DATE PLOTTED: DD/MM/YYYY
 GGG-41

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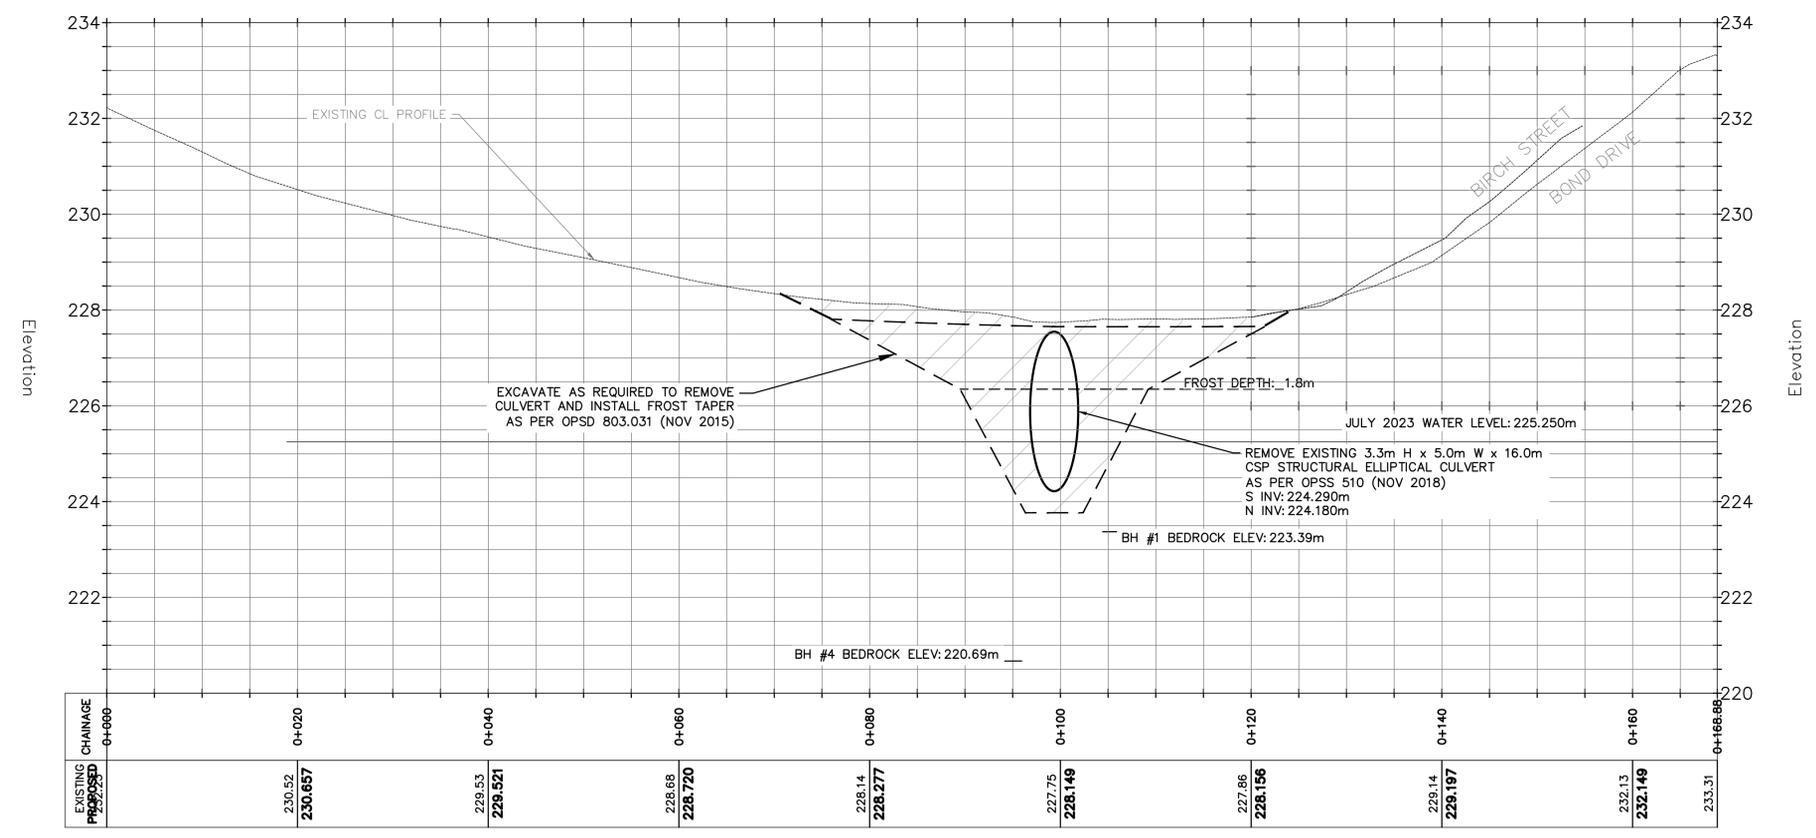
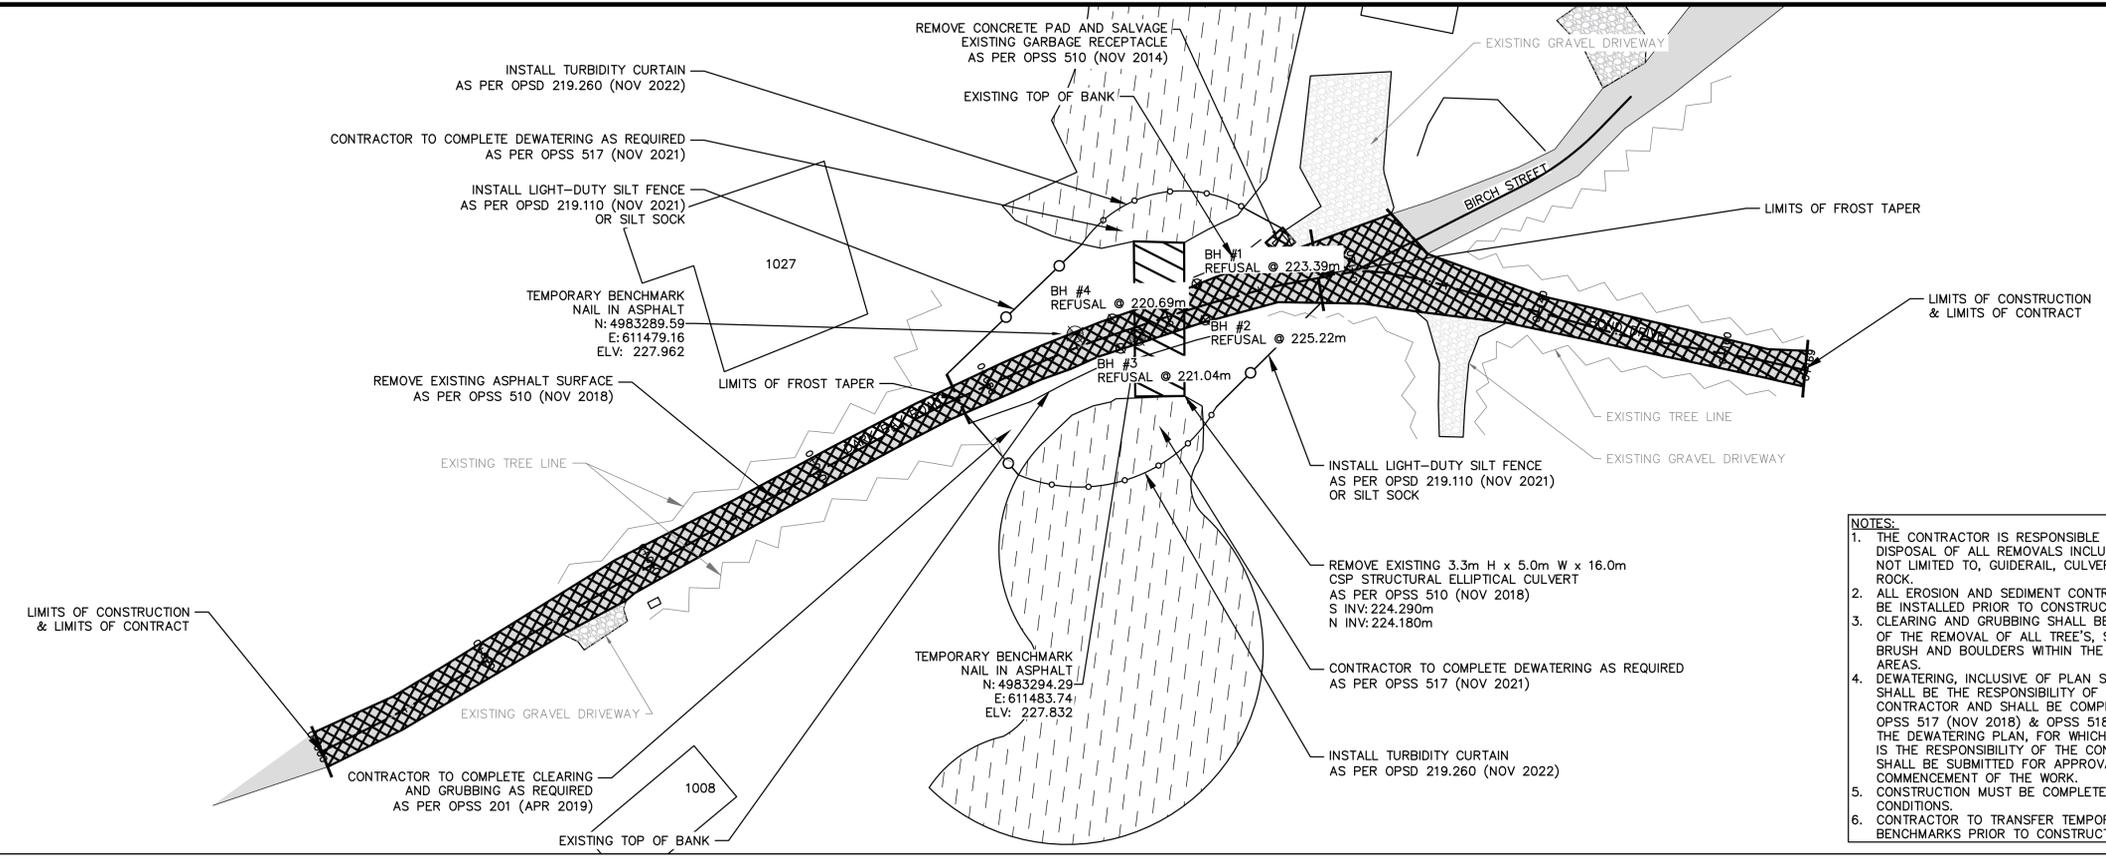
- NOTES:
1. ALL WORK SHALL BE IN ACCORDANCE WITH RELEVANT CODES AND GUIDELINES.
 2. ALL DRAWINGS AND ADDENDA ARE TO BE READ AS, AND IN CONJUNCTION WITH THE SPECIFICATIONS.
 3. ALL EQUIPMENT SHALL BE INSTALLED AS SPECIFIED OR APPROVED EQUIVALENT.
 4. CONTRACTOR MUST CHECK AND VERIFY ALL DIMENSIONS BEFORE PROCEEDING WITH WORK AND BE RESPONSIBLE FOR SAME.
 5. CONTRACTOR MUST REPORT ANY DISCREPANCIES TO ENGINEER FOR RESOLUTION BEFORE COMMENCING THE WORK.
 6. ANY CHANGES MUST BE APPROVED BY THE ENGINEER.

A A DETAIL NO.
 B B DRAWING NO. - WHERE DETAILED

LEGEND

ASPHALT	
REMOVALS	
CULVERT	
WATER	
TREE LINE	
SILT FENCE	
TURBIDITY CURTAIN	
CONSTRUCTION LIMITS	

- NOTES:
1. THE CONTRACTOR IS RESPONSIBLE FOR THE DISPOSAL OF ALL REMOVALS INCLUDING, BUT NOT LIMITED TO, GUIDERAIL, CULVERTS, SOIL AND ROCK.
 2. ALL EROSION AND SEDIMENT CONTROLS SHALL BE INSTALLED PRIOR TO CONSTRUCTION.
 3. CLEARING AND GRUBBING SHALL BE INCLUSIVE OF THE REMOVAL OF ALL TREE'S, SHRUBS, BRUSH AND BOULDERS WITHIN THE REMOVAL AREAS.
 4. DEWATERING, INCLUSIVE OF PLAN SUBMISSIONS, SHALL BE THE RESPONSIBILITY OF THE CONTRACTOR AND SHALL BE COMPLETED AS PER OPSS 517 (NOV 2018) & OPSS 518 (APR 2017). THE DEWATERING PLAN, FOR WHICH THE DESIGN IS THE RESPONSIBILITY OF THE CONTRACTOR, SHALL BE SUBMITTED FOR APPROVAL PRIOR TO COMMENCEMENT OF THE WORK.
 5. CONSTRUCTION MUST BE COMPLETED IN DRY CONDITIONS.
 6. CONTRACTOR TO TRANSFER TEMPORARY BENCHMARKS PRIOR TO CONSTRUCTION.



NORTH
 STAMP

PROJECT
DARK BAY ROAD BRIDGE REPLACEMENT
 MUSKOKA, ON

DRAWING TITLE
REMOVALS PLAN & PROFILE

REVISION	DATE
05	
04	ISSUED FOR TENDER 06/05/24
03	ISSUED FOR 100% REVIEW 27/11/23
02	ISSUED FOR 80% REVIEW 11/10/23
01	ISSUED FOR 30% REVIEW 28/08/23

DESIGNED BY
R. ASSELSTINE

DRAWN BY
S. HIGH

REVIEWED BY
R. ASSELSTINE

APPROVED BY
K. HAWLEY

PROJECT DATE
07/11/2023
 (DD/MM/YYYY)

PROJECT #
23-5-5361
 SCALE
 HOR: 1:350
 VER: 1:70

DRAWING #
C1

(METRIC SCALE - ALL DIMS IN METERS UNLESS OTHERWISE SPECIFIED)

CAD OPERATOR: Shih
CAD FILE: X:\Kingston Archives\5000 - Municipal\2023\2355361 - Dark Bay Road Bridge Replacement\Drawings\Working\Drawings\Dark Bay Bridge Replacement - IT.dwg
DATE PLOTTED: DD/MM/YYYY
PLOT SCALE: AS NOTED

GENERAL

- All works to be installed in accordance with current Township of Muskoka Guidelines, Canadian Highway Bridge Design code, and Ontario Provincial Standard Specifications and Drawings unless specified otherwise.
- Prior to construction, Contractor to verify all dimensions, culvert inverts and utility locates and identify possible conflicts.
- All environmental protection measures are the responsibility of the contractor.
- Any traffic signs or information signs removed/damaged during construction are to be replaced at the contractors costs.
- All utility poles to be braced as necessary.
- The location of utilities is approximate only, and the exact location should be determined by consulting the municipal authorities and utility companies concerned. The contractor shall prove the location of utilities and shall be responsible for adequate protection from damage during construction.

TRAFFIC CONTROL

- All traffic control/pedestrian signing as per OTM.
- A full road closure is acceptable during weekends in accordance with SP.

GRADING


- Finished surfaces shall be at a minimum grade of 2% unless otherwise noted.
- Slopes in landscaped areas shall not exceed 3H:1V.
- All existing elevations and grades are to be verified by the contractor prior to grading.
- Utilities are to be located prior to construction.
- All ground surfaces shall be graded to prevent ponding and without low areas except where approved swale or catchbasin outlets are provided.
- The contractor is responsible for reviewing proposed grades with conflicts regarding the proposed structures.
- Sub-grade shall be graded at a minimum of 3%, until a lower ditch is encountered an existing surface that has positive drainage away from the roadway.

SITE WORKS


- Where in earth subgrade compacted granular depths to be 150 mm Granular A and 300mm Granular B. Provide 3% crossfall on subgrade.
- All disturbed areas to be remediated with 100 mm topsoil and seed as per OPSS 802 & OPSS 804.

SEDIMENT AND EROSION CONTROL NOTES


- All erosion and sediment controls shall be installed prior to construction and monitored and maintained by the Contractor throughout the construction process, until all disturbed areas have been re-vegetated then the temporary sediment and erosion control measures must be removed once the site has been stabilized/completed of site works.
- All erosion and sediment control measures shall be inspected after prior to and after each rainfall to the satisfaction of the Contract Administrator.
- Any disturbed areas not scheduled for further construction within forty-five (45) days will be provided with a suitable temporary mulch and seed cover within seven (7) days of completion. Regardless of site specific items detailed on the plans, the Contractor shall install erosion control measures to suit the proposed work methods to control sediment from running off the site prior to any disturbance.
- Following construction, disturbed areas, as well as proposed grassed and vegetated surfaces, shall be reinstated as soon as practical.
- All roads used to access the site shall be kept clean to the satisfaction of the Director of Public Works.
- Dewatering shall be completed as per OPSS 517. The Contractor shall submit a plan for approval by the Contract Administrator prior to dewatering. Any permits required for dewatering shall be obtained by the Contractor prior to proceeding with the work.

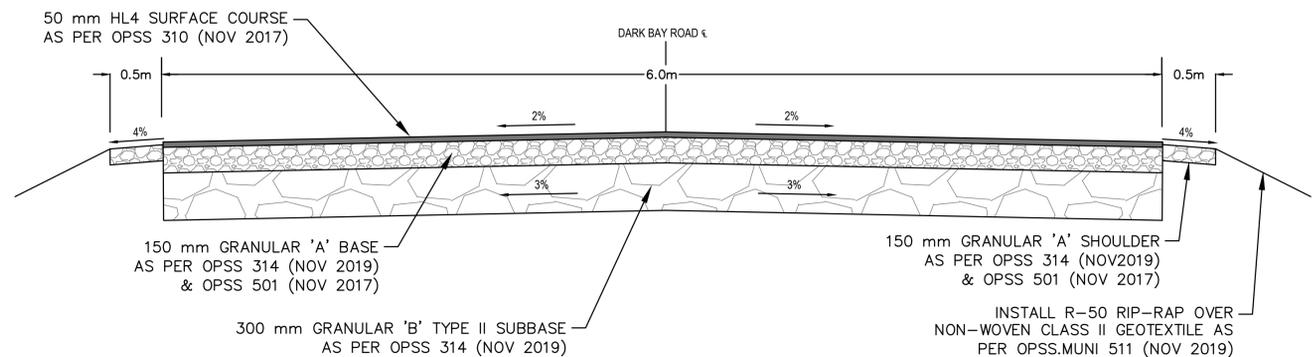


01 'TYPICAL' ROAD REINSTATEMENT STA 0+075 TO STA 0+120
SCALE: NTS

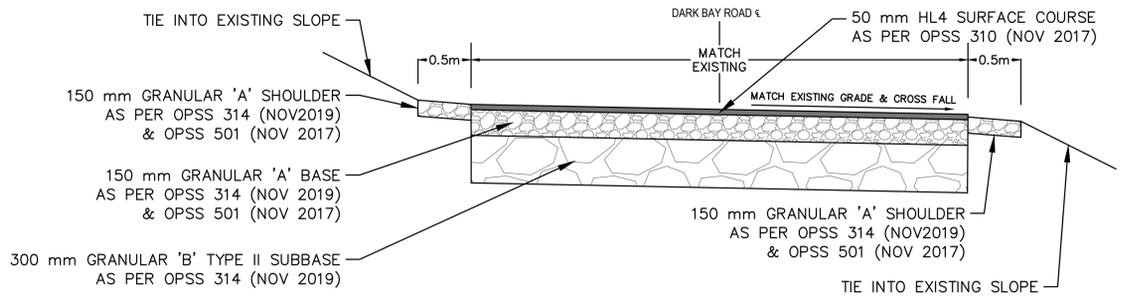


02 'TYPICAL' ROAD REINSTATEMENT STA 0+000 TO STA 0+075 & STA 0+120 TO STA 0+169
SCALE: NTS

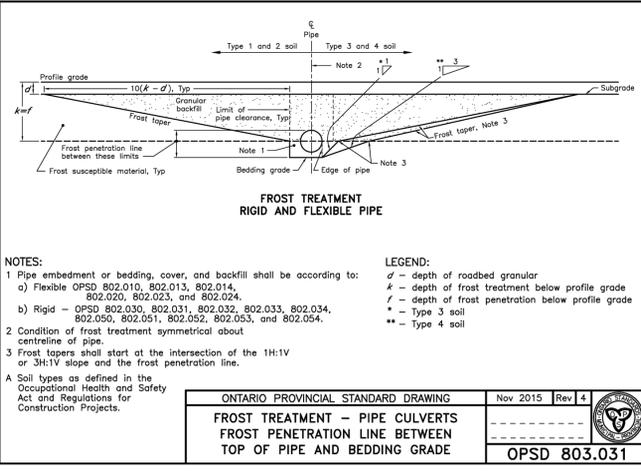


ONTARIO PROVINCIAL STANDARD DRAWING
FROST TREATMENT - PIPE CULVERTS
FROST PENETRATION LINE BETWEEN TOP OF PIPE AND BEDDING GRADE
Nov 2015 Rev 4
OPSD 803.031

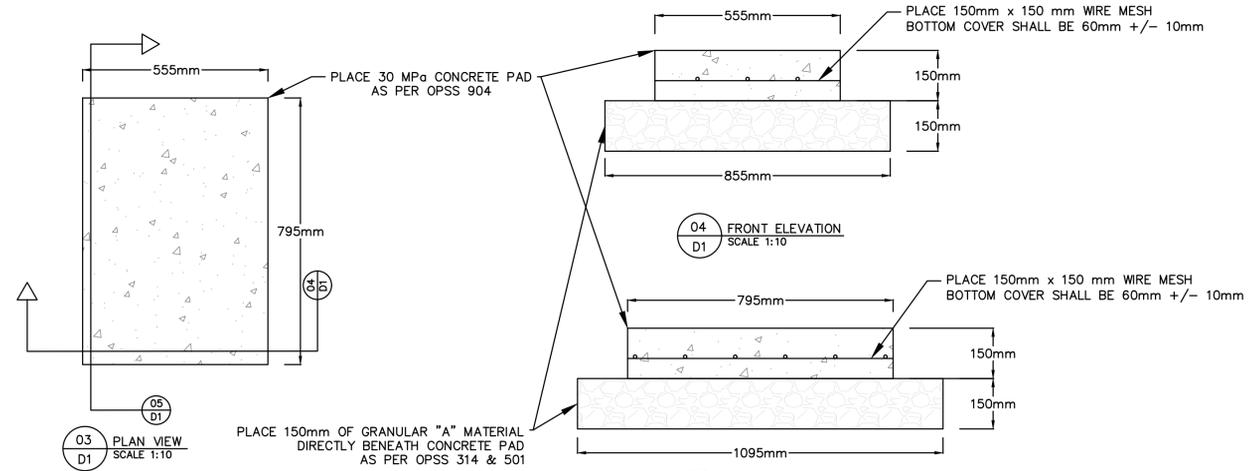


03 PLAN VIEW SCALE 1:10
04 FRONT ELEVATION SCALE 1:10
05 SIDE ELEVATION SCALE 1:10

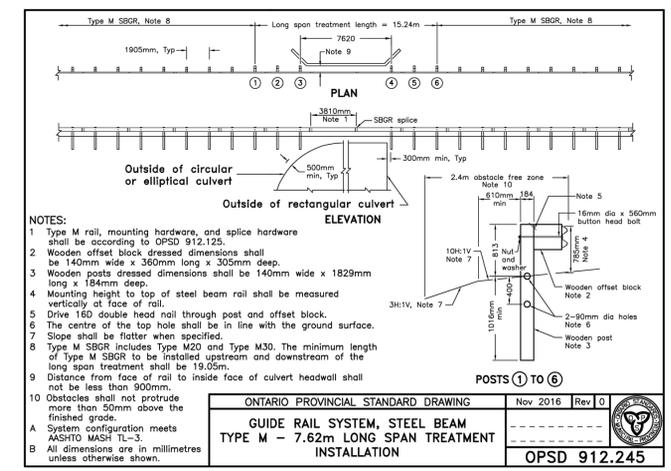


ONTARIO PROVINCIAL STANDARD DRAWING
GUIDE RAIL SYSTEM, STEEL BEAM
TYPE M - 7.62m LONG SPAN TREATMENT INSTALLATION
Nov 2016 Rev 0
OPSD 912.245

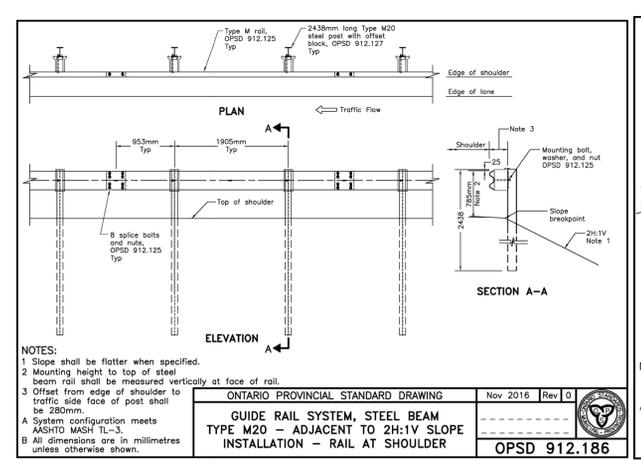

ONTARIO PROVINCIAL STANDARD DRAWING
GUIDE RAIL SYSTEM, STEEL BEAM
TYPE M20 - ADJACENT TO 2H:1V SHOULDER
INSTALLATION - RAIL AT SHOULDER
Nov 2016 Rev 0
OPSD 912.186

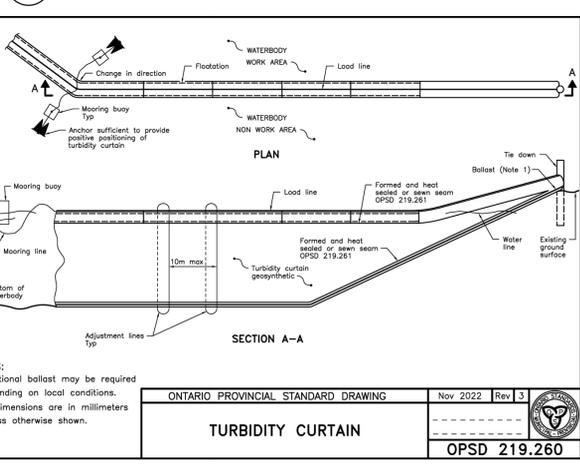

ONTARIO PROVINCIAL STANDARD DRAWING
TURBIDITY CURTAIN
Nov 2022 Rev 3
OPSD 219.260

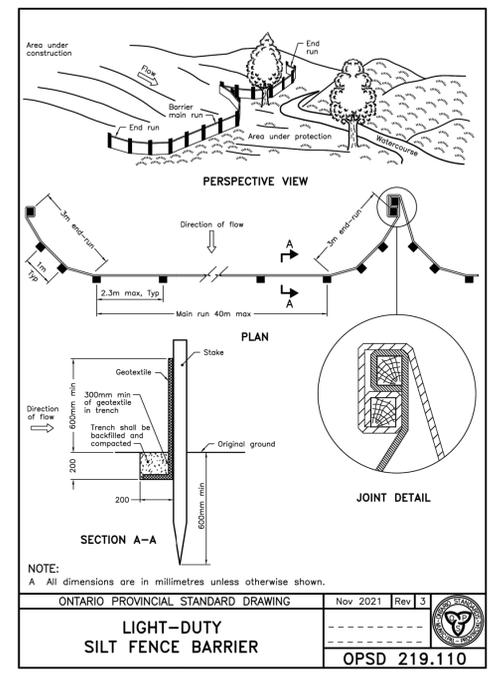

ONTARIO PROVINCIAL STANDARD DRAWING
LIGHT-DUTY SILT FENCE BARRIER
Nov 2021 Rev 3
OPSD 219.110

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B	B DRAWING NO. - WHERE DETAILED

STAMP

PROFESSIONAL ENGINEER
K. T. HAWLEY
100149851
MAY 6/24
PROVINCE OF ONTARIO

PROJECT
DARK BAY ROAD
BRIDGE REPLACEMENT

MUSKOKA, ON

DRAWING TITLE
DETAILS

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DRAWING #	D1	