

### 1 Bailey Street Port Carling, ON P0B 1J0

E: planning@muskokalakes.ca P: 705-765-3156 F: 705-765-6755

### **COMMITTEE OF ADJUSTMENT - NOTICE OF HEARING**

THE CORPORATION OF THE TOWNSHIP OF MUSKOKA LAKES

To consider an application for a proposed minor variance to Zoning By-law 2014-14 pursuant to Section 45 of the Planning Act, R.S.O., 1990, Chapter P. 13, as amended. **This notice has been sent to you for information and does not require any response unless you wish to make one.** 

File No.: A-70/25 Roll No.: 9-15-056-07

Owners:	Michael Lapalme & Robyn Jury Lapalme, 81 Fontevielle Crescent, Woodbridge,				
	ON, L4H 3X1				
Address &	6 Island M69A				
Description:	Part 8, Plan 35R-3100, Todern Island, (Monck)				
Zoning:	ng: Waterfront Residential (WR5- Lake Muskoka Schedule: 37				
7) (Category 1 Lake)					
Hearing Date: Monday, November, 10th, 2025 at 9:00 a.m.					



Take further notice that this public hearing will be held in a hybrid forum with electronic Zoom participation, and in-person format for those wishing to attend in-person. The hearing will be held in the **Council Chambers, Municipal Office, 1 Bailey Street, Port Carling, ON**. Should you wish to view an electronic copy of the Notice of Hearing for the above-noted application, please visit <a href="https://www.muskokalakes.ca/planning-notices/">https://www.muskokalakes.ca/planning-notices/</a> or scan the QR code.

### **Explanation of the Purpose and Effect:**

The applicants propose to construct a sauna, a dock and single storey boathouse with a roof top sundeck. The applicants also propose to recognize an as-built propane tank. The following is a summary of the requested variances:


Variance	ZBL 2014-14 Section(s)	Description	Permitted	Proposed	Variance	Proposal
Α	4.1.3.6 & 4.1.3.7	Lot Coverage Within 200 ft. of a HWM	10% (3,885 sq. ft.)	10.6% (4,137 sq. ft.)	0.6% (252 sq. ft.)	Construct a Single Storey Boathouse with Rooftop Sundeck & Sauna
В	4.1.3	Minimum Required Front Yard Setback	66 ft.	18 ft.	48 ft.	Recognize an As- Built



			Propane Tank

A key map of the subject property and the applicants' site plan and any drawings are included in this notice.

KEY MAP, A-70/25 (LAPALME)

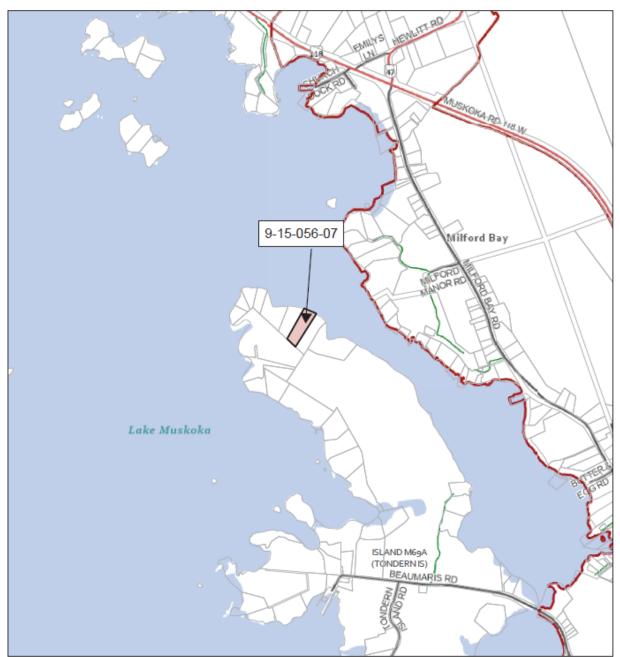

NOT A PLAN OF SURVEY. FOR INFORMATIONAL PURPOSES ONLY.



For more information, please contact the Planning Division weekdays between 8:15 a.m. and 4 p.m. at the Municipal Office, or at <a href="mailto:planning@muskokalakes.ca">planning@muskokalakes.ca</a> or by phone at (705) 765-3156. Please quote the file number noted above.

### **How to Participate:**

### **Submit Comments in Writing**



Submit comments to <u>planning@muskokalakes.ca</u>, deliver in-person, or mail to P.O. Box 129, 1 Bailey Street, Port Carling, ON, P0B 1J0. For correspondence to be included on the agenda, please submit your comments by: November 6<sup>th</sup>.

Please note that comments can still be submitted after the agenda has been published. Personal information collected in response to this Notice of Hearing will be used to assist staff and Council to process this application and will be made public.

### **Active Participation In-Person or on Zoom**



Hybrid hearings are held at 9:00 a.m. on the above-noted hearing date in Council Chambers at the Municipal Office. For more information about participating via Zoom, visit <a href="https://www.muskokalakes.ca/zoom">www.muskokalakes.ca/zoom</a>

If you wish to speak to the Committee of Adjustment at the hearing by electronic participation, please contact <a href="mailto:planning@muskokalakes.ca">planning@muskokalakes.ca</a> by 9:00 a.m. on the regular business day preceding the scheduled hearing.

### Watch the Hearing Online



You can access the hearing from YouTube on the Township of Muskoka Lakes YouTube Channel. If the live webcast fails, the hearing recording will be posted under the Government Portal on <a href="https://www.muskokalakes.ca">www.muskokalakes.ca</a>

**FAILURE TO PARTICIPATE IN HEARING:** If you do not participate in the hearing it may proceed in your absence and, except as otherwise provided in the Planning Act, you will not be entitled to any further notice in the proceedings.

**DECISION & APPEALS:** If you wish to be notified of the decision of the Committee of Adjustment in respect to this application, you must make a written request to <a href="mailto:planning@muskokalakes.ca">planning@muskokalakes.ca</a>. Furthermore, **no one other than** the applicant, the municipality, certain public bodies, a "specified person" (as defined by the Planning Act 1(1)), and the minister may file an appeal of the decision of the Committee of Adjustment in respect of the proposed variance. If they do not make a written submission to the Secretary Treasurer before the variance is approved or refused, then the Ontario Land Tribunal may dismiss the appeal.

**PLEASE NOTE:** The Committee of Adjustment is a judicial body which makes decisions solely on the information gathered as a Committee. Committee members are not to be contacted prior to the hearing date to avoid a conflict of interest.

Dated at the Township of Muskoka Lakes this 28<sup>th</sup> day of October, 2025.

Chelsea Ward, Secretary-Treasurer Committee of Adjustment <a href="mailto:planning@muskokalakes.ca">planning@muskokalakes.ca</a>



## 6 ISLAND M69A (TONDERN ISLAND) TOWNSHIP OF MUSKOKA LAKES Parcel: 445309001505607


ZONE REQUIREMENT	S			
Zoning Description	WR5-7			
Lot Area	99,05	0 sq ft		
Lot Area (Within 60m)	38,85	0 sq ft		
Lot Frontage	199'			
Maximum Lot Coverage % (Total Lot)	10% (9,905 SQ FT)			
Maximum Lot Coverage % (Within 60m)	10% (3,885 SQ FT)			
YARD SETBACKS (PROPOSED BUILDING)				
	FEET	METERS		
Side Setback Dock & 1 Stry. B.H (Min):	30	9.1		
Width Dock (25% Max)	49.75	4.62		
Width Boathouse (16% Max)	31.84	2.95		
Max Boathouse Legnth	50	15.2		
BUILDING HEIGHT (PROPOSED BUILDING)				
Height (Max):	16	4.9		

AREAS OF EXISTING STRUCTURES				
	SQFT.	SQM.		
EXISTING COTTAGE & ROOF AREAS	2,737	254		
EXISTING DOCK (TO DEMOLISH)	864	80.26		
EXISTING PRIVY	16.9	1.57		
EXISTING PROPANE	77	7.15		

AREA OF PROPOSED STRUCTURES			
	SQFT.	SQM.	
Boathouse	1300	120	
Sauna	100	9.2	

PROPOSED LOT COVERAGE CALCULATIONS					
SQFT SQM %					
PROPOSED TOTAL LOT	4,231	393.07	4.27		
PROPOSED WITHIN 60M	4,214	391.49	10.84		

EXISTING LOT COVERAGE CALCULATIONS					
SQFT SQM %					
EXISTING TOTAL LOT	2,831	263	2.85		
EXISTING WITHIN 60M	2,814	261.42	7.24		

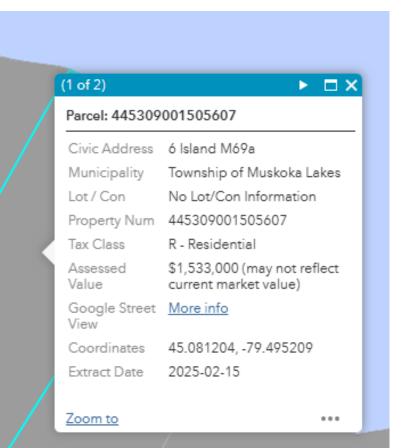



# SITE PLAN CONTROL & CONSERVATION A separate Site plan control application will be required for this site due to the WATERFRONT RESIDENTIAL designation.

### DEFINITIONS

Shall mean, when used in reference to a building or structure the vertical distance between the lowest finished ground surface at the exterior of the building and the highest point of the roof; or, in the case of a boathouse or sun shelter, the vertical distance between the top of the dock and the highest point of the roof; or

of a sundeck, the vertical distance between the lowest finished ground surface adjacent to the perimeter of the sundeck. In the case where a sundeck is joined to a building or other structure, the height of the sundeck and the height of the building or structure shall be measured separately, and each shall comply with the provisions of this Bylaw.

### 2. LOT COVERAGE

Shall mean that percentage of area covered by buildings and structures including accessory buildings and structures on the lot inclusive of any such area covered on lands adjacent to the lot in a WOS Zone and excluding non-roofed structures and docks. Lot coverage shall be calculated using the exterior faces of the exterior walls. If there are no walls, lot coverage shall be calculated using the exterior faces of the supporting posts. Where roof overhangs exceed 1.2 m (4 ft.) the portions exceeding 1.2 m (4 ft.) will be included in lot coverage

SITE PLAN NOTES

- All construction activities are restricted from the shoreline buffer. All native tree, shrub and grass species shall be maintained. All new plantings shall be maintained and preserved or replanted in the event of damage or deterioration.
- All dimensions on site plan are listed is in imperial unless otherwise noted.

The owner agrees to preserve all natural vegetation and healthy trees and any natural water courses. All vegetation between the dwelling and the high water mark shall remain in its natural state.

- All tree removal and grading/filling must comply with the tree preservation and site alteration by-laws.
- All site drainage shall be slope away from proposed construction by a minimum of 2%
- All construction activities are restricted from the shoreline
- Install silt fencing during the construction and development period.
- Silt fencing shall be constructed of heavy material to prevent sediment runoff and to protect and prevent the land from soil erosion and the creation of sedimentation into nearby waterbodies.
- The fence shall be properly trenched in to the ground. Fence must be maintained in good working order,
- All external lighting shall be dark sky by-law compliant.

inspected regularly and repaired as needed.

### within the excavation. Stakes to be secured into the trench at approx. 8' o.c. Backfill the trench and tamp the soil to ensure silt fence

Inspect and maintain the silt fence to ensure soil erosion is being controlled.

SILT FENCE INSTALLATION

development period to prevent runoff and to protect the

All silt fencing shall be constructed of heavy material and

be put in place prior to any site alteration or construction.

The fence shall be properly trenched in to the ground.

The fencing should not be removed until all works have

Mark out the path for the silt fence, ensure path encloses

At the proposed silt fence location, excavate a v-shaped

trench, a minimum of 8" below grade. Install silt fencing

the area of construction, while providing adequate construction allowance for materials and site workers.

Fence must be maintained in good working order,


inspected regularly and repaired as needed.


Install silt fencing during the construction and

land from soil erosion.

### NOTES

- Existing driveway to be used as Construction Access.
   Following construction, driveway to be reinstated for use.
   Any disturbed areas as a result of construction are to be renaturalized.
- Any pathways constructed within the shoreline buffer, shall be max. 6' wide.
- The path shall meander and be constructed of permeable substances.
- No trees or riparian vegetation shall be removed.
- Hardscape made of flagstone must be Dry Laid, placed on a bed of gravel and sand, any gaps between flagstone shall consist of permeable material such as pebbles, sand, mulch, or ground cover plantings.
- All native trees, shrubs and grass species shall be maintained within 50 feet of the shoreline. Tree removal and site alteration shall comply with the Township's Tree Conservation and Site Alteration By-laws.
- All proposed plantings shall be native species.
- Coniferous trees shall be a min. 6 ft. in height.
- Deciduous trees shall have a min. 1.5" caliper at chest

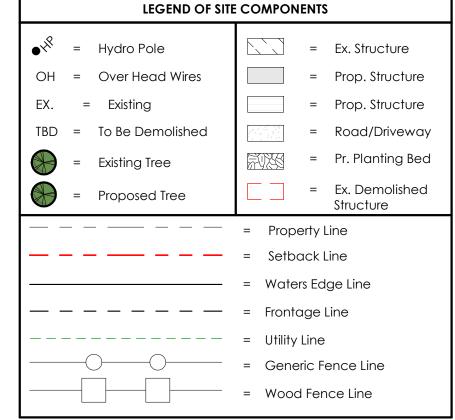

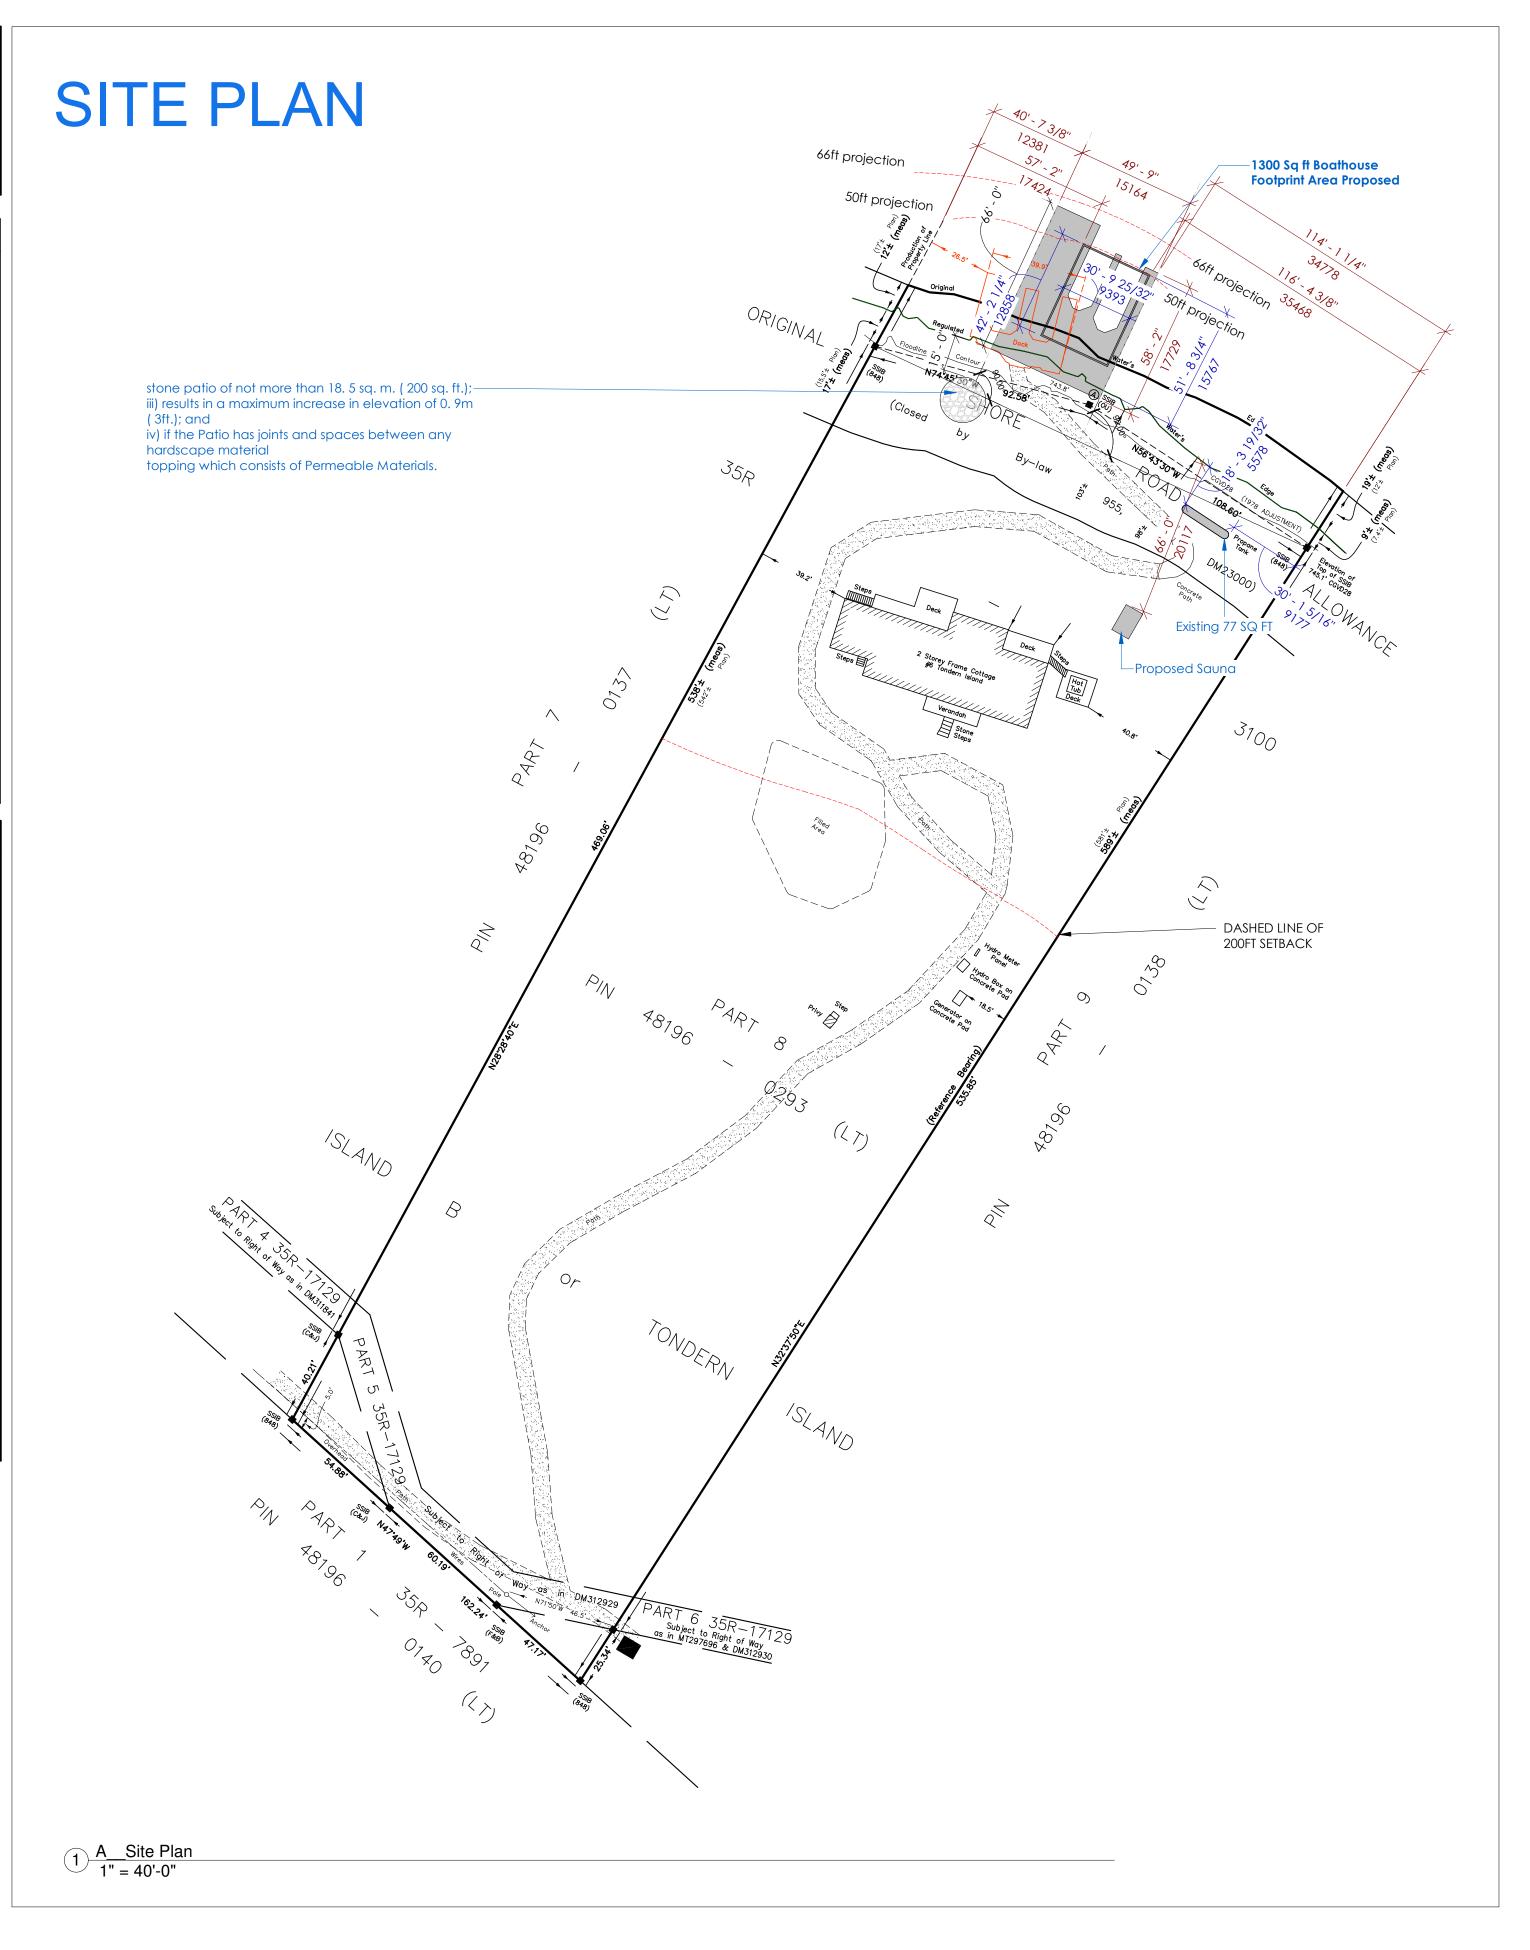

NOT TO SCALE

# Spencer Douglas

PLANNING ■ DESIGN

No. Description Date

### SHEET LIST

Cover Page A-001 Site Plan & Lot Statistics A-002 Notes & Legends A-102 Main Floor Plan A-103 Roof Plan A-200 Elevations A-400 **Architectural Details** S-102 Main Floor Plan - Walls & Headers S-102.1 Main Floor Plan - Floors & Beams S-104 Roof Plan S-200 Steel Schematic S-300 Sections & Details S-301 Sections & Details

### **Design Criteria:**

Ground Snow Load (Ss): 3.1kPa
Associated Rain Load (Sr): 0.4 kPa
Specified Snow Load: 2.105 kPa
Base Wind Presssure (q/150): 0.4kPa

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6 Island M69a (tondern island)

LaPalme

Township of Muskoka Lakes

Engineer Seal

The undersigned has reviewed and takes responsibility for this design, and has the qualifications and meets the requirements set out in the Ontario Building Code to be a designer.

Required unless design is exempt under 2.17.5.1 of the building code.

SIGNATURE

**REGISTRATION INFORMATION**Required unless design is exempt under 2.17.4.1 of the

building code.

heet Name

Site Plan & Lot Statistics

Project Number SDYY-MM##


Date 8/28/2025 12:57:47 PM


Drawn By xx


Checked By xx

A-001

cale As indicated

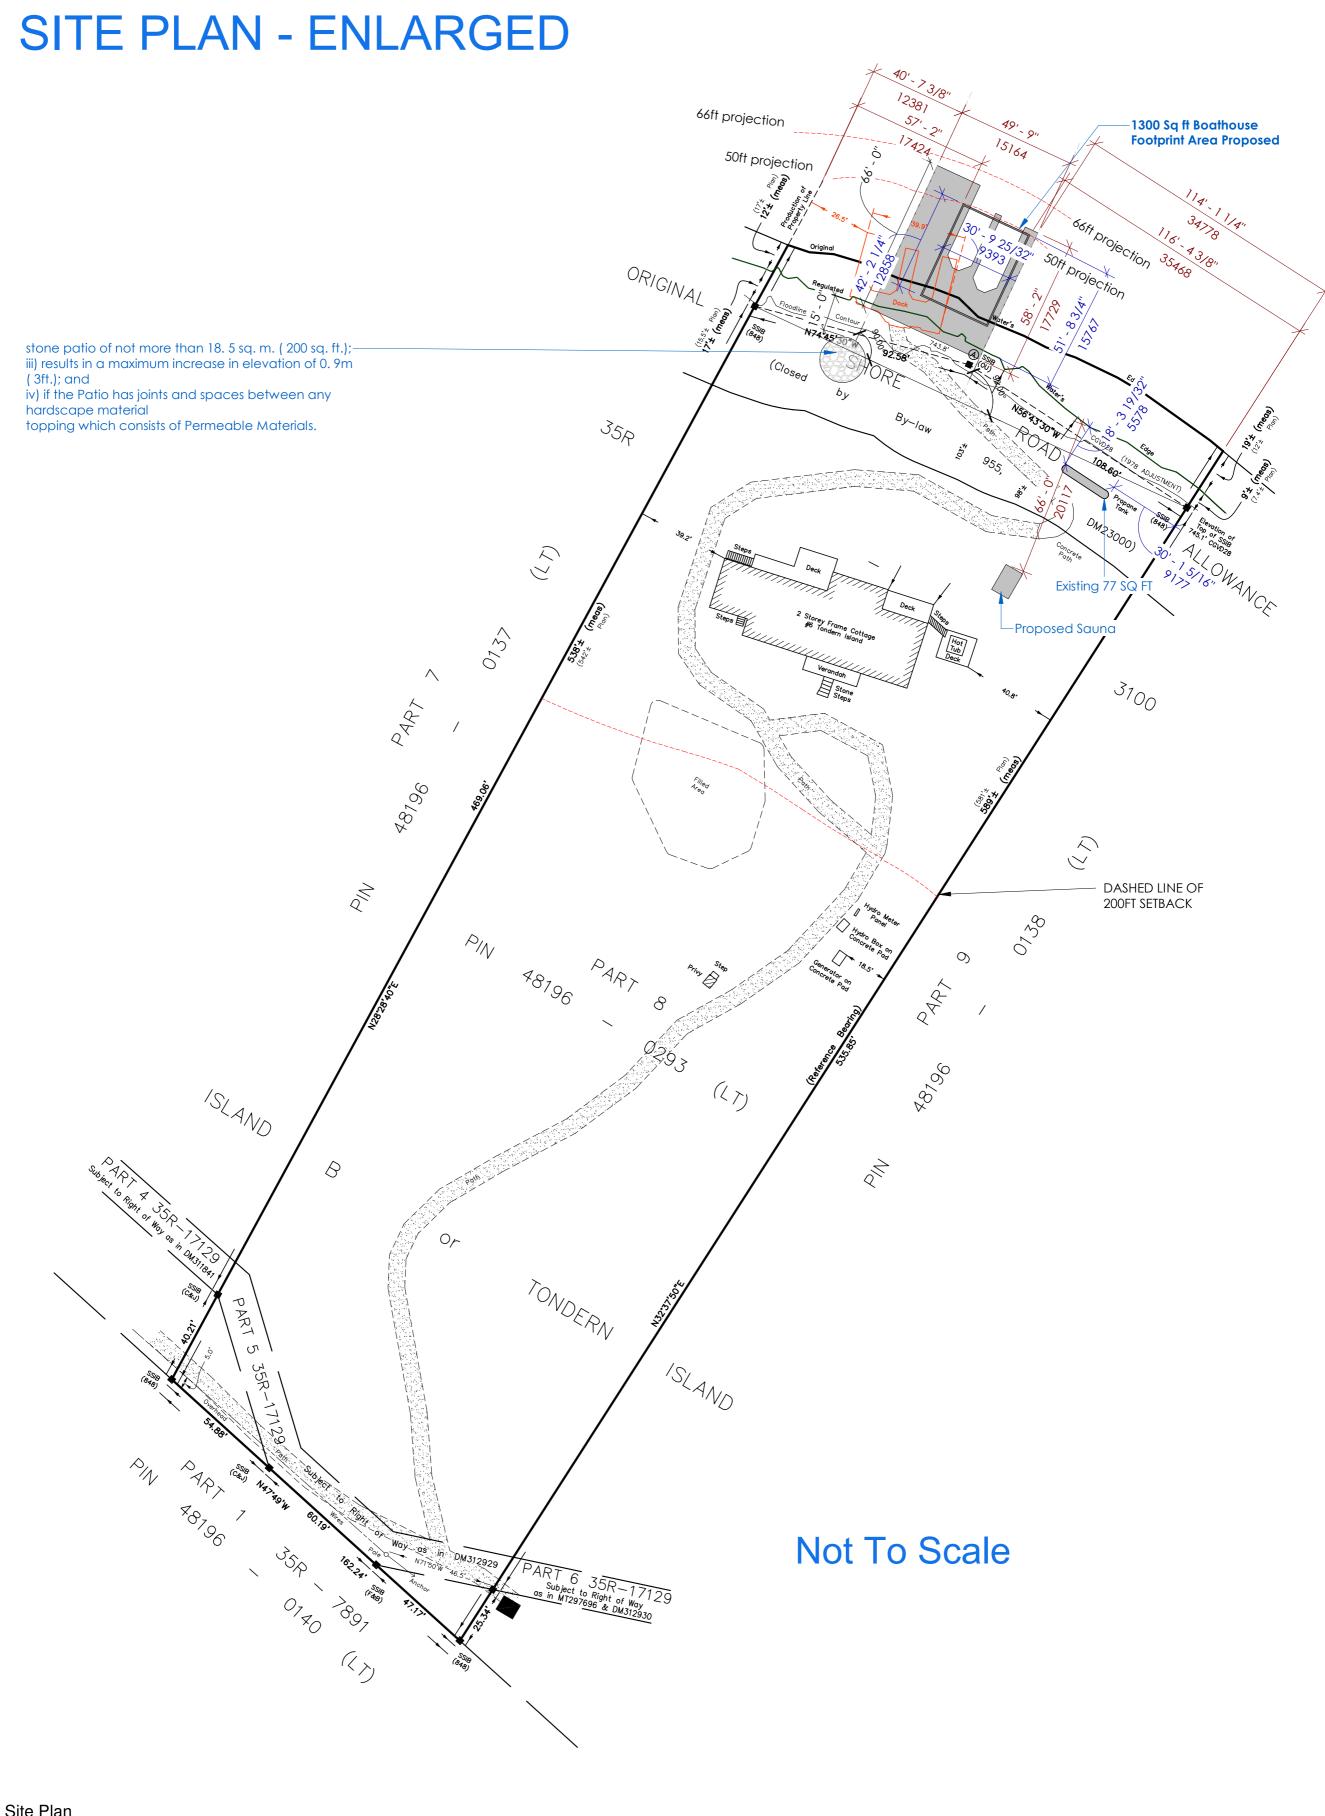

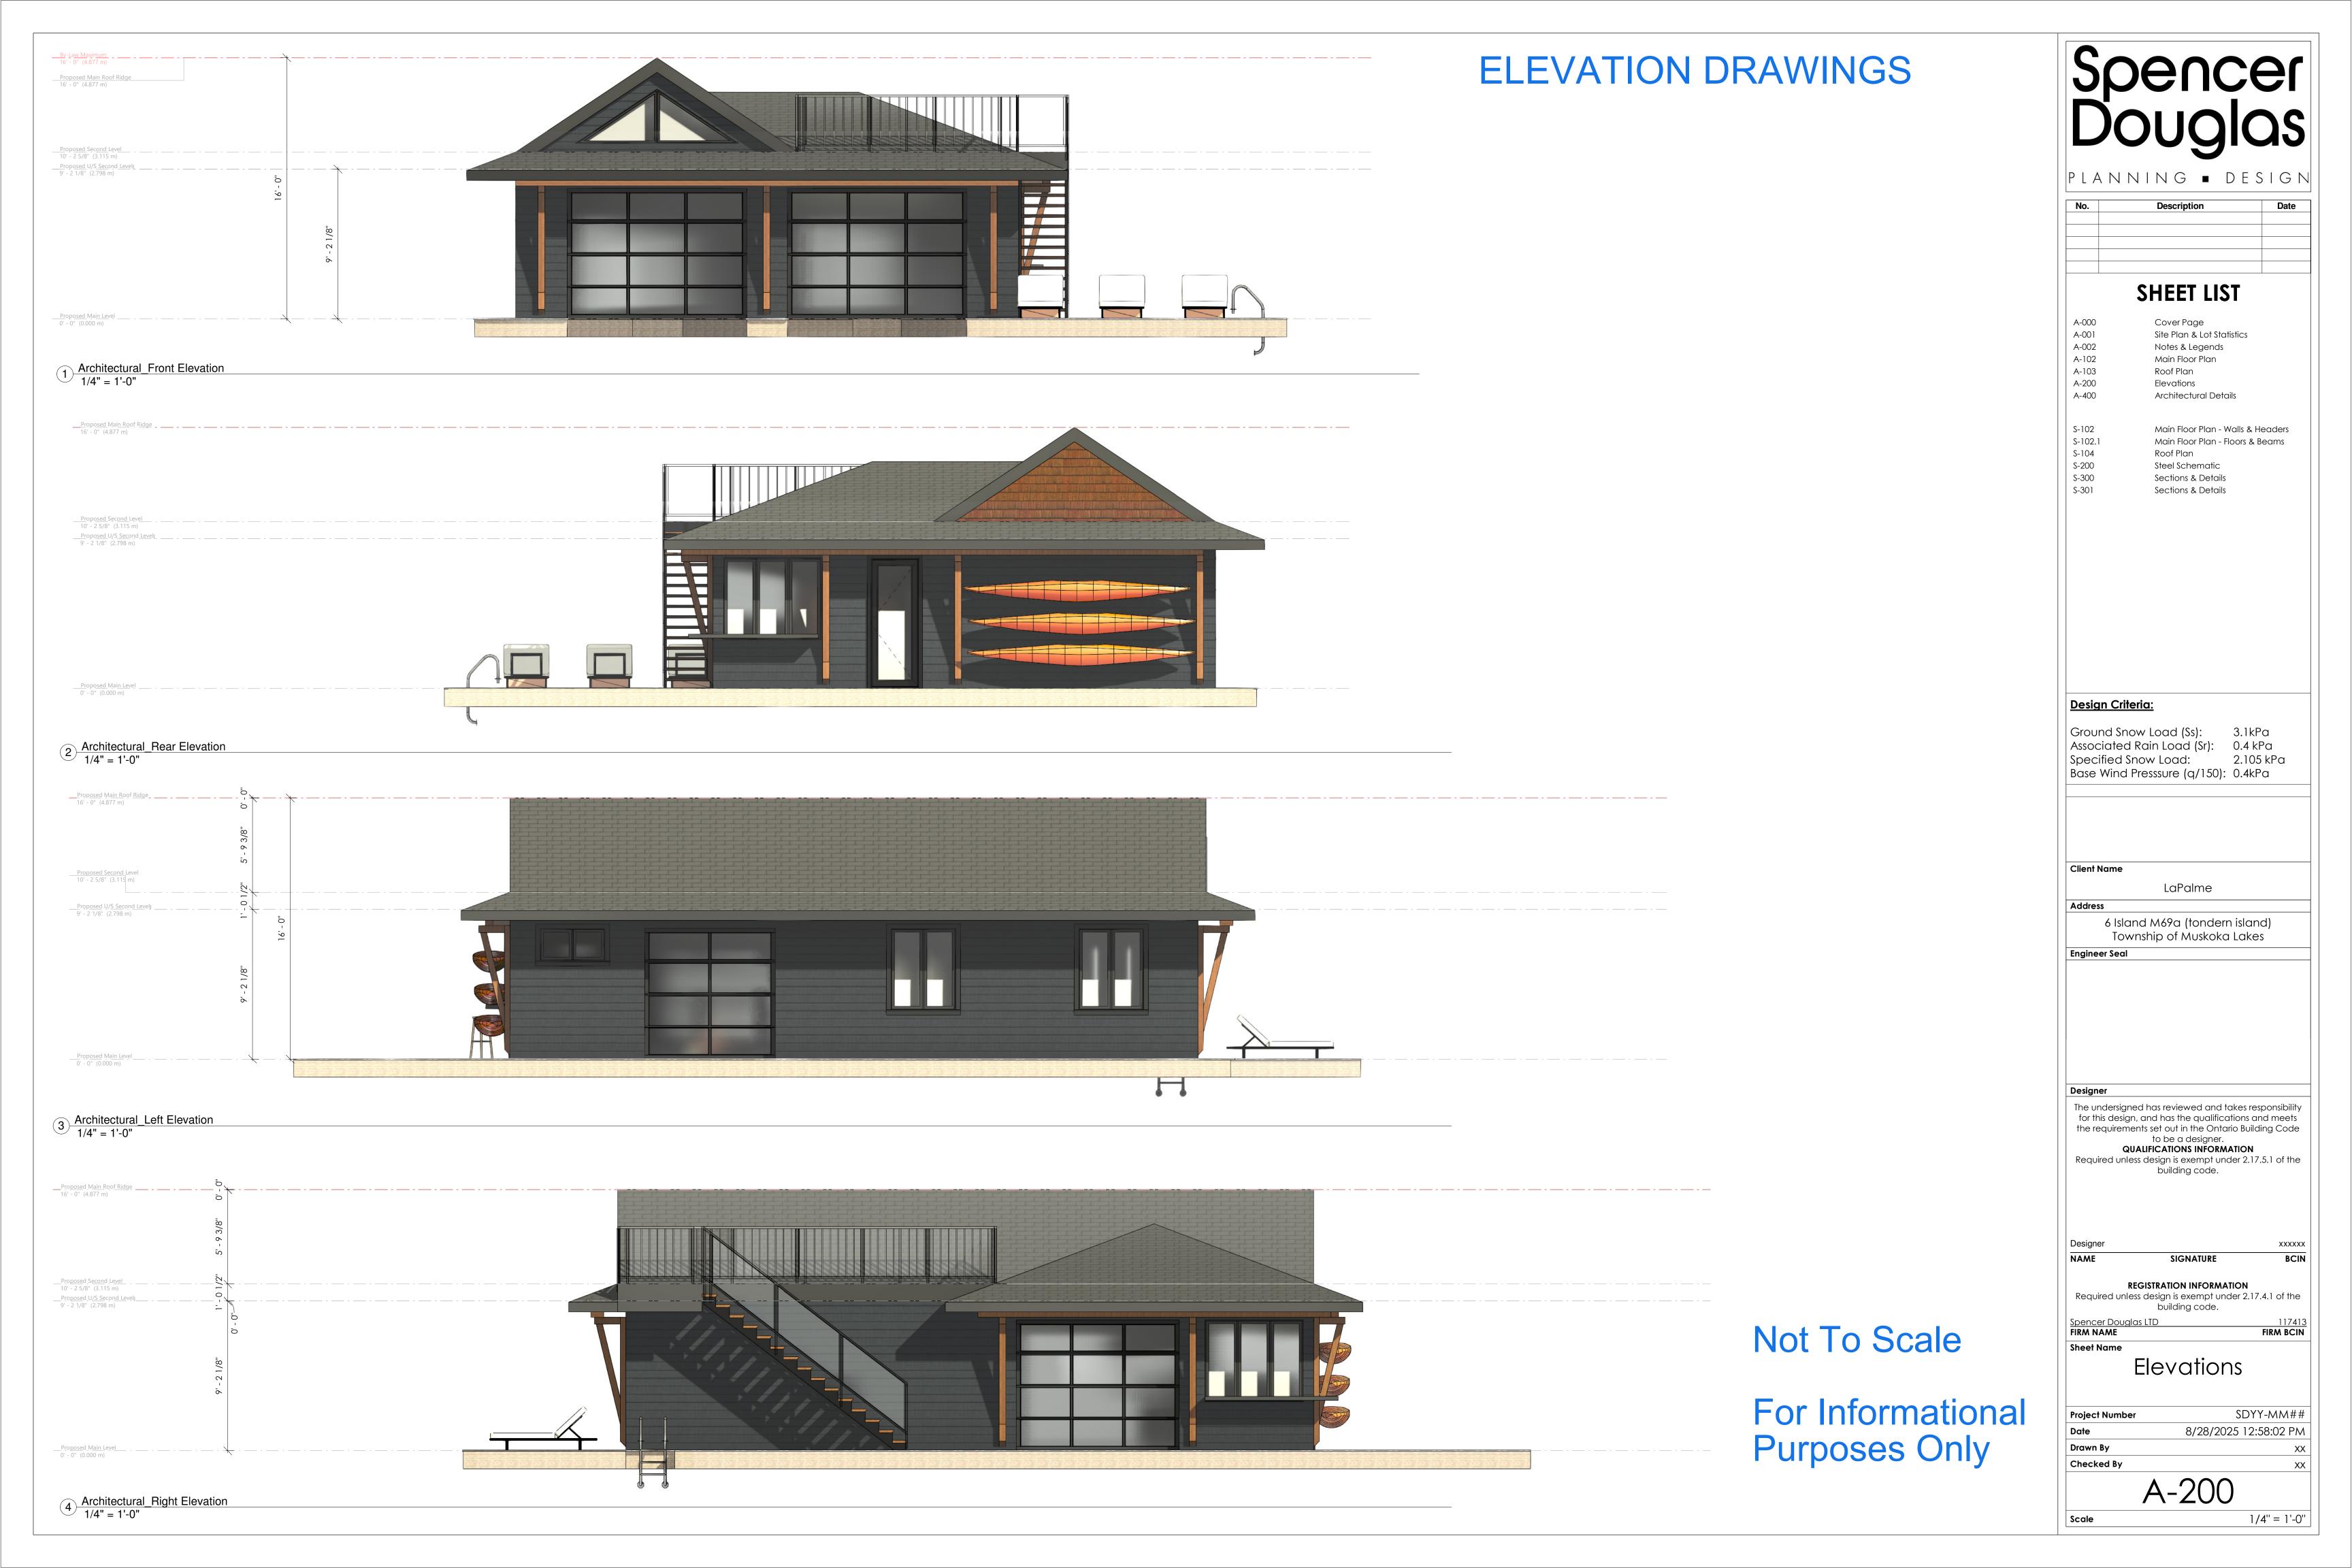

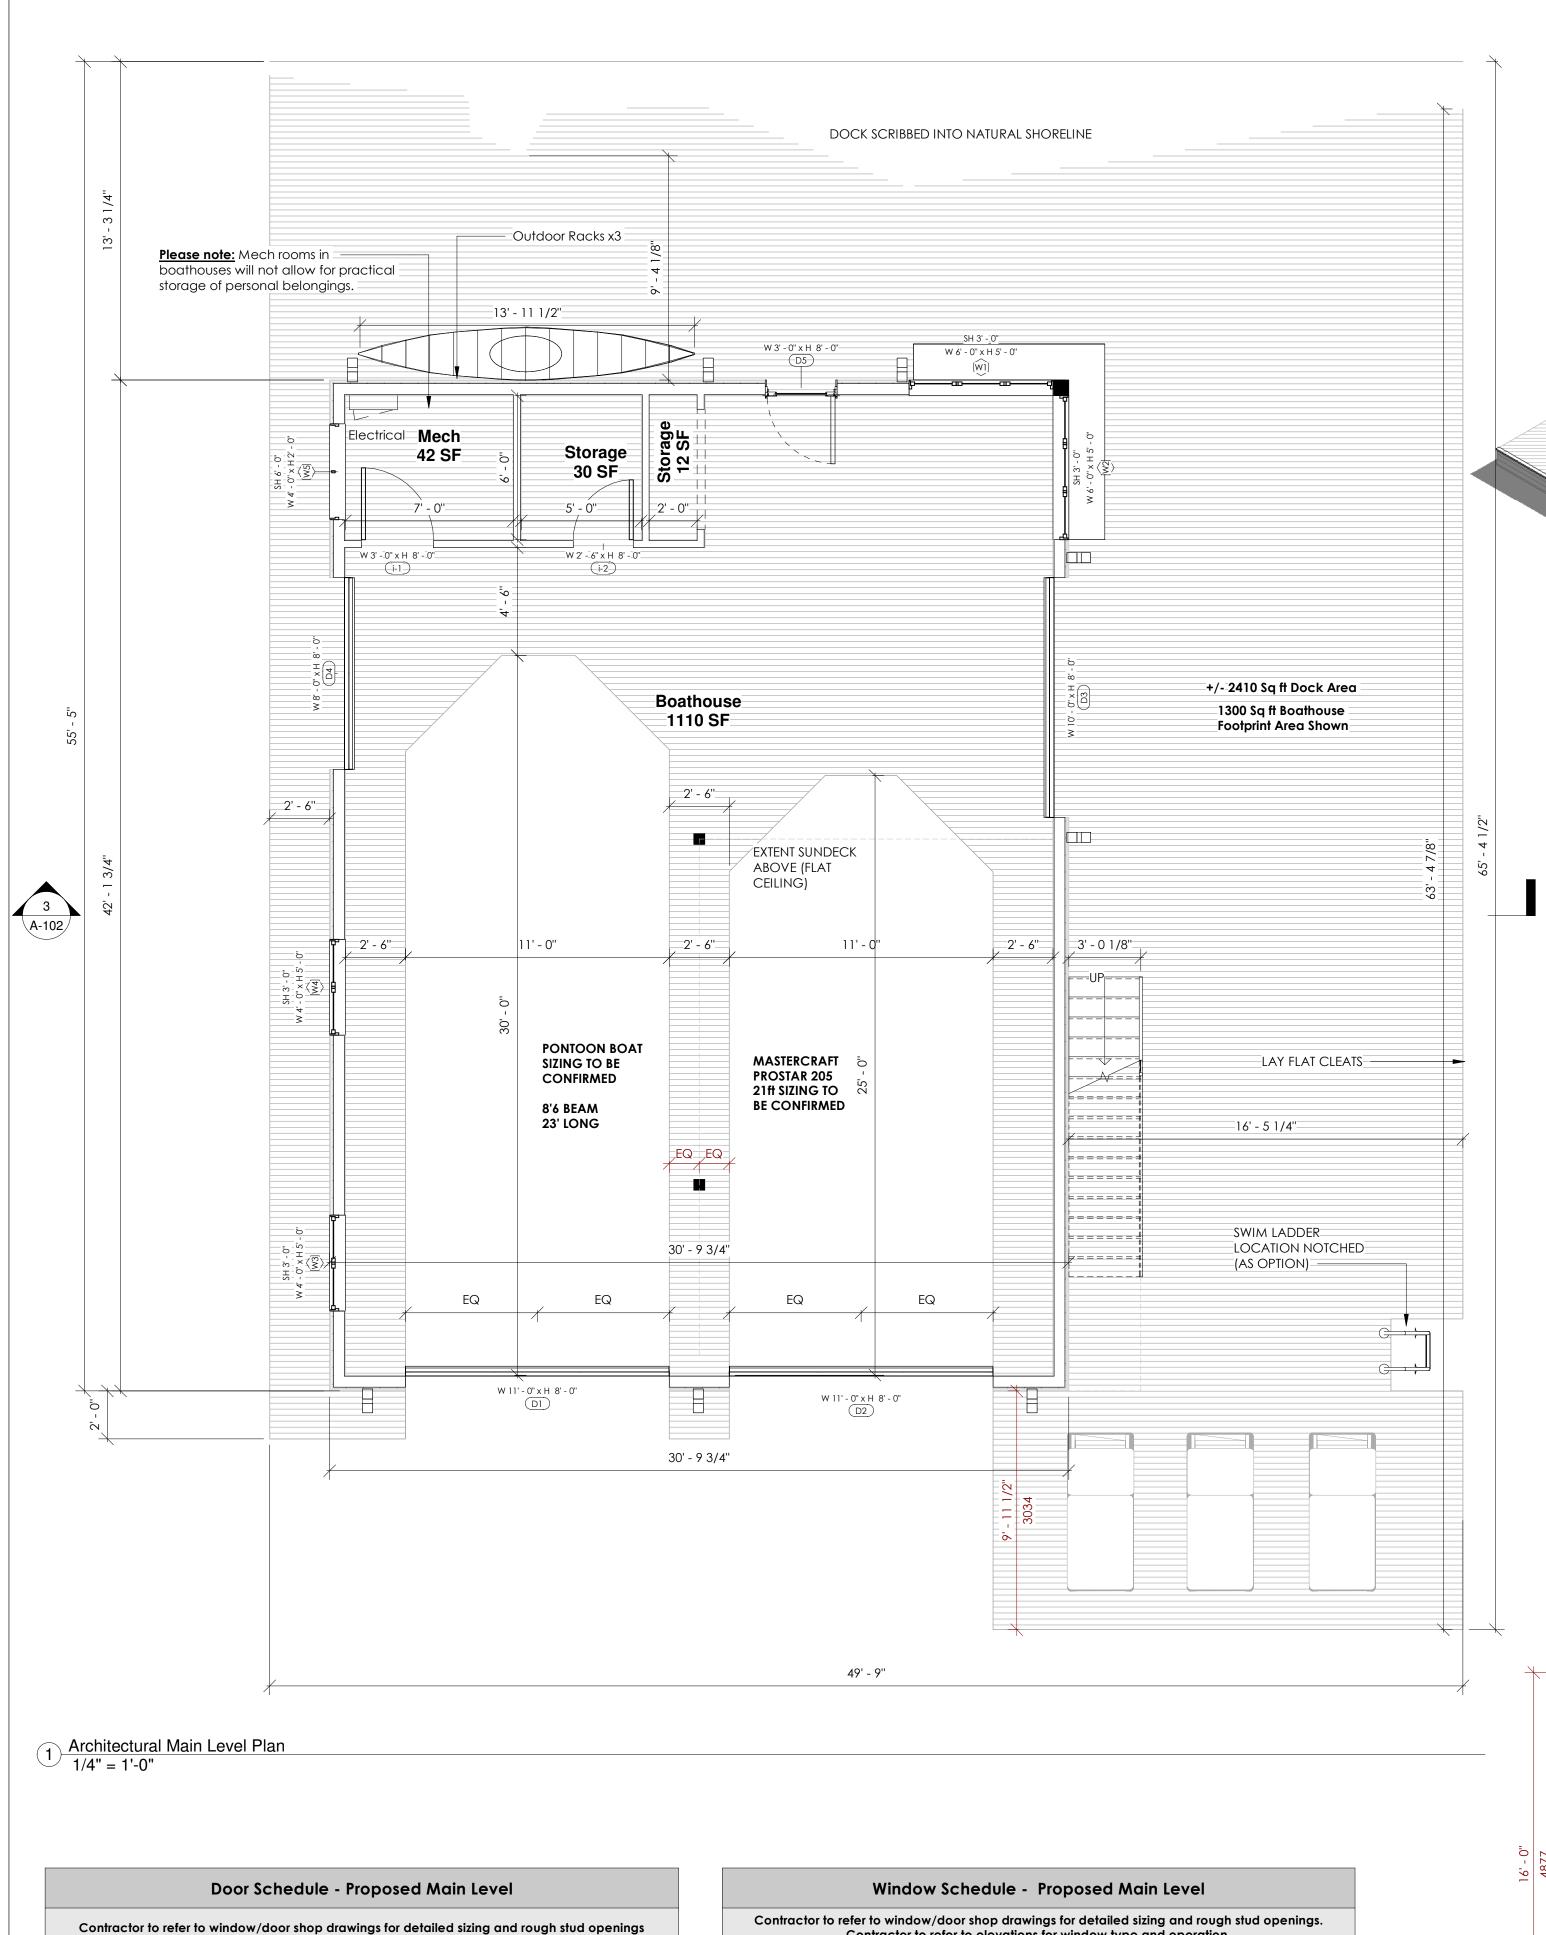

#### 

2-1/8" Thick Aluminum Sectional Door | 132"

2-1/8" Thick Aluminum Sectional Door | 132"

-1/8" Thick Aluminum Sectional Door | 120"

-1/8" Thick Aluminum Sectional Door | 96"

In-Swing Patio Door

Unframed Opening


Single Swing Interior Door

Proposed Main Level
T/O Main Level

Proposed Main Level

Proposed Main Level

# MAIN FLOOR PLAN

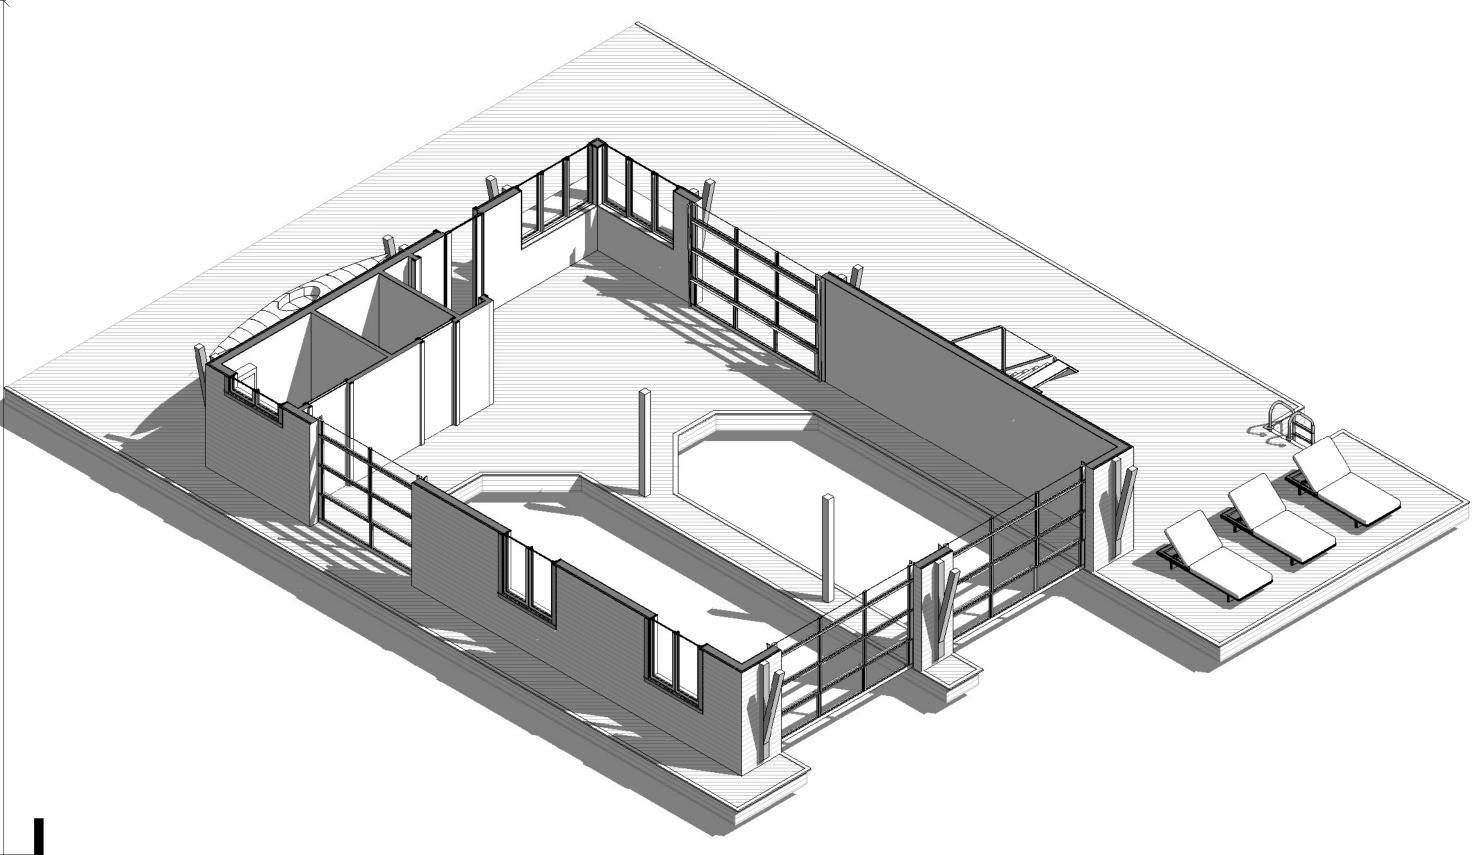

# Not To Scale For Informational Purposes Only



3 Section 1 1/4" = 1'-0"

# Spencer Douglas

PLANNING • DESIGN

No. Description Date

### SHEET LIST

A-000 Cover Page
A-001 Site Plan & Lot Statistics
A-002 Notes & Legends
A-102 Main Floor Plan
A-103 Roof Plan
A-200 Elevations
A-400 Architectural Details

S-102 Main Floor Plan - Walls & Headers S-102.1 Main Floor Plan - Floors & Beams S-104 Roof Plan

S-200 Steel Schematic S-300 Sections & Details S-301 Sections & Details

### Design Criteria:

Ground Snow Load (Ss): 3.1kPa
Associated Rain Load (Sr): 0.4 kPa
Specified Snow Load: 2.105 kPa
Base Wind Presssure (q/150): 0.4kPa

Client Name

LaPalme

6 Island M69a (tondern island)

Township of Muskoka Lakes

Engineer Seal

Address

The undersigned has reviewed and takes responsibility for this design, and has the qualifications and meets the requirements set out in the Ontario Building Code to be a designer.

QUALIFICATIONS INFORMATION

Required unless design is exempt under 2.17.5.1 of the building code.

Designer

SIGNATURE BC

**REGISTRATION INFORMATION**Required unless design is exempt under 2.17.4.1 of the

building code.

Spencer Douglas LTD 117413

FIRM NAME FIRM BCIN

Sheet Name

Main Floor Plan

Project Number SDYY-MM##

Date 8/28/2025 12:57:51 PM


Drawn By xx

Checked By xx

A-102

ale 1/4" = 1'-0"

# **ROOF PLAN**

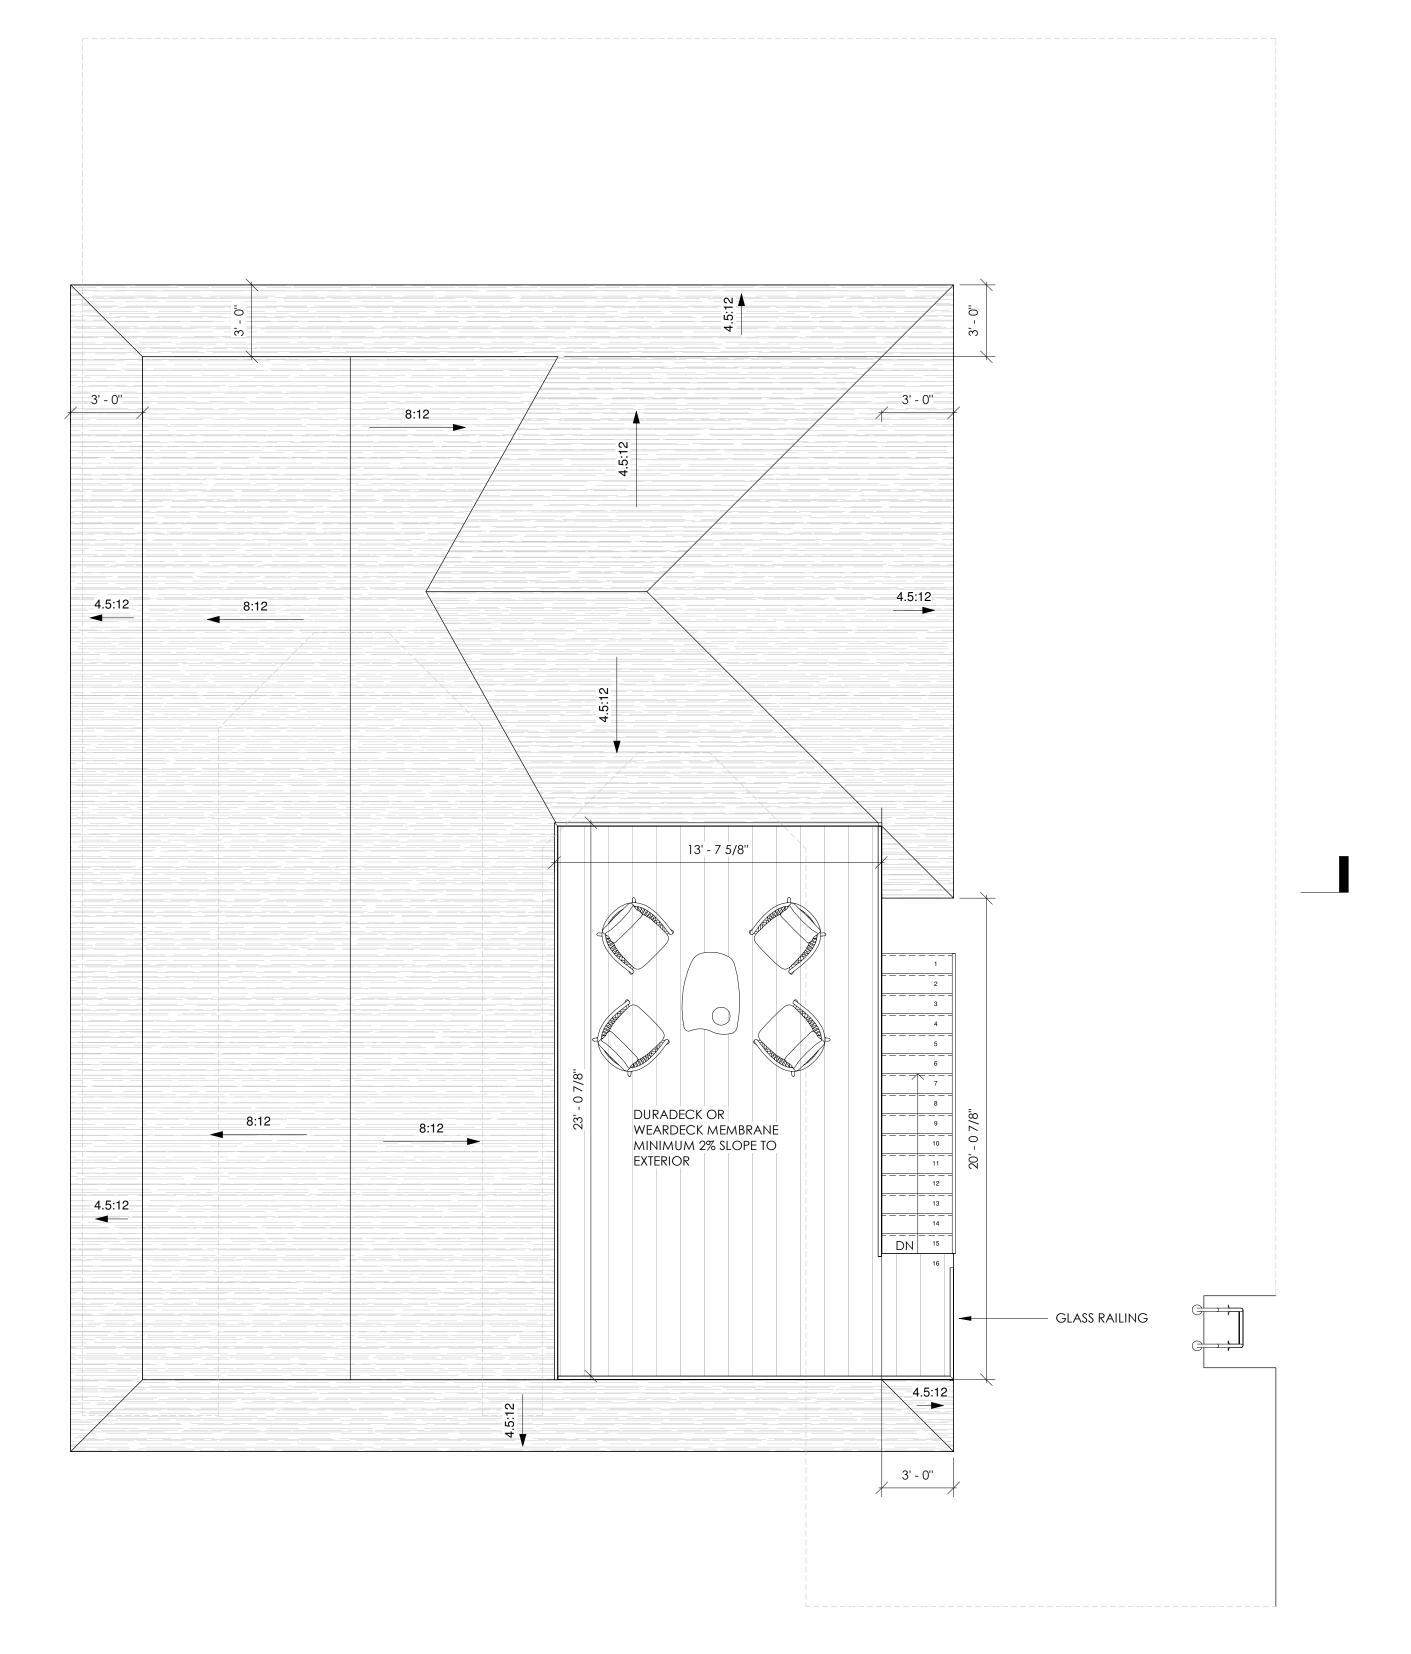

Not To Scale

For Informational Purposes Only

Spencer Douglas

PLANNING - DESIGN

Description

## SHEET LIST

Cover Page A-001 Site Plan & Lot Statistics A-002 Notes & Legends A-102 Main Floor Plan A-103 Roof Plan A-200 Elevations Architectural Details

S-102 Main Floor Plan - Walls & Headers S-102.1 Main Floor Plan - Floors & Beams S-104 Roof Plan

S-200 Steel Schematic S-300 Sections & Details S-301 Sections & Details

### Design Criteria:

Ground Snow Load (Ss): Associated Rain Load (Sr): Specified Snow Load: Base Wind Presssure (q/150): 0.4kPa

Client Name

LaPalme

6 Island M69a (tondern island) Township of Muskoka Lakes

Engineer Seal

The undersigned has reviewed and takes responsibility for this design, and has the qualifications and meets the requirements set out in the Ontario Building Code to be a designer.

QUALIFICATIONS INFORMATION

Required unless design is exempt under 2.17.5.1 of the building code.

SIGNATURE

117413 FIRM BCIN

1/4" = 1'-0"

REGISTRATION INFORMATION Required unless design is exempt under 2.17.4.1 of the building code.

Roof Plan

Project Number SDYY-MM## 8/28/2025 12:57:51 PM Drawn By Checked By

A-103

Architectural Roof Plan
1/4" = 1'-0"